
# HILLSIDE DR CASS RESIDENCE

LA JOLLA CA.

## 619.858.2345 F. 619.858.2344 P.O.Box. 84180 San Diego Ca. 92138 office@cdgius.com www.cdgius.com

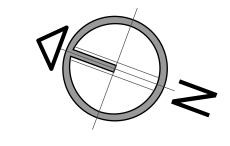

NORTH 2nd review - 5.19.2020

3rd review - 5.28.2020 4th review - 10.14.2020

DATE. 12.15.2020 CITY SUBMITTAL. SAN DIEGO SCALE.

INDICATE IN DRAW DRAW.

E.M. JOB NO.

SHEET TITLE:

TITLE PAGE

T.O 1

#### **NOTES NOTES CON'T** SYMBOL LEGEND STORM QUALITY NOTES **GREEN BUILDING NOTES CON'T** 09. AEROSOL PAINTS AND COATING SHALL BE COMPLAINT WITH PRODUCT WEIGHTED MIR LIMITS FOR VOC AND THIS PROJET SHALL COMPLY WITH ALL CURRENT REQUIREMENTS OF THE STATE PERMIT: CALIFORNIA REGIONAL OTHER TOXIC COMPOUNDS AS SPECIFIED IN SECTION 4.504.3.2 OF THE CALIFORNIA GREEN BUILDING CODE. WATER QUALITY CONTROL BOARD (SDRWQCB), SAN DIEGO MUNICIPAL STORM WATER PERMIT, THE CITY OF SAN LEVEL HEADS DATUM/WORK POINT 10. A CERTIFICATION COMPLETED AND SIGNED BY EITHER THE GENERAL CONTRACTOR OR SUBCONTRACTOR, DIEGO DEVELOPMENT CODE, AND THE STORM WATER STANDARS MANUAL. OR THE BUILDING OWNER CERTIFYING THAT THE PAINT, STAIN, AND ADHESIVES, COMPLIES WITH THE 11. CARPET AND CARPET SYSTEM SHALL BE COMPLIANT WITH VOC LIMITS (SECTIONS4.504.3) A LETTER FROM AFTER A STORM EVENT THAT CAUSES A BREECH IN INSTALLED CONSTRUCTION BMP'S WHICH MAY COMPROMISE COMPLIES WITH THE CALIFORNIA GREEN BUILDING CODE CENTERLINE STEP SYMBOL HIGH PERFORMANCE PRODUCT DATABASE GREATER THAN 7 CALENDAR DAYS ARE TO BE COVERED. ALL REMOVABLE BMP DEVICES SHALL BE IN PLACE AT (E) SPOT ELEVATION NEW SPOT ELEVATION THE END OF EACH WORKING DAY W 5 DAY RAIN PROBABILITY FORECAST EXCEEDS 40%. SCHOOL PROGRAM SECTION IS DRAWN 3) A CONCRETE WASHOUT SHALL BE PROVIDED ON ALL PROJECTS WHICH PROPOSE THE CONSTRUCTION OF 13. HARDWOOD PLYWOOD, PARTICLEBOARD, MEDIUM DENSITY FIBERBOARD (MDF), COMPOSITE WOOD PRODUCT USED IN THE INTERIOR OR EXTERIOR OF THE BUILDING SHALL MEET THE REQUIREMENTS FOR ANY CONCRETE IMPROVEMENTS WHICH ARE TO BE POURED IN PLACE ON SITE. 4) THE CONTRACTOR. SHALL RESTORE ALL EROSION/SEDIMENT CONTROL DEVICES TO WORK ORDER AFTER EACH RUN-OFF PRODUCING RAINFALL OR AFTER ANY MATERIAL BREACH IN EFFECTIVENESS. 14. A CERTIFICATION COMPLETED AND SIGNED BY THE GENERAL CONTRACTOR, SUN CONTRACTOR OR BUILDING 5) ALL SLOPES THAT ARE CREATED OR DISTURBED BY CONSTRUCTION ACTIVITY MUST BE PROTECTED DETAIL SECTION REFERENCE FLOW ARROW AGAINST EROSION AND SEDIMENT TRANSPORT AT ALL TIMES. DETAIL SECTION NUMBER 6) THE STORAGE OF ALL CONSTRUCTION MATERIALS AND EQUIPMENT MUST BE PROTECTED AGAINST ANY - SHEET ON WHICH SECTION IS DRAWN 15. BUILDING MATERIALS WITH VISIBLE SIGNS OF WATER DAMAGE SHALL NOT BE INSTALLED, WALLS AND POTENTIAL RELEASE OF POLLUTANTS INTO THE ENVIRONMENT. FLOORS FRAMING SHALL NOT BE ENCLOSED WHEN FRAMING MEMBERS EXCEED 19% MOISTURE CONTENT 7) POST CONSTRUCTION BMP NOTE: ALL REPLACED AND NEW IMPERVIOUS SURFACES TO DRAIN TO NEARBY 16. THE MOISTURE CONTENT OR BUILDING MATERIAL USED IN WALL AND FLOOR FRAMING IS CHECKED BEFORE LANDSCAPED AREAS FOR FILTRATION PURPOSES. WALL TAG ENCLOSURE. MOISTURES CONTENT SHALL BE VERIFIED BY EITHER PROBE TYPE OR CONTRACT TYPE MOISTURE **GENERAL NOTES** 01. SEE SHEET C-1 (GRADING & DRAINAGE) FOR ALL EXISTING AND PROPOSED UTILITIES ON THE SITE OR IN THE SHEET NUMBER **ABREVIATIONS** ADJACENT RIGHT OF WAY. 02. PROVIDE BUILDING ADDRESS NUMBER VISIBLE AND LEGIBLE FROM THE STREET OR ROAD FRONTING THE PROPERTY PER FHPS POLICY P-00-6. 03. NO EXISTING BUS STOP. DRAWING EXISTING 04. NO FIRE HYDRANTS WITHIN 600 FEET LAMINATE(D) ELEVATION REFERENCE 05. DECK NOTE: IGNITION-RESISTANT MATERIALS THAT COMPLIES WITH THE PERFORMANCE REQUIREMENTS OF LAVATORY BOTH SFM STANDARD 12-7A-4 ANS SFM STANDARD 12-7A-5. PERPENDICULAR LAG BOLT **EXPANSION JOINT** POUND(S) MECHANICAL NOTES LINEAR FOOT (FEET) LEFT HAND LIBRARY ELEVATION 01. WINDOW OPERATION IS NOT A PERMISSIBLE METHOD OF PROVIDING BATHROOM EXHAUST FOR HUMIDITY ANCHOR BOLT ELECTRICAL ABOVE ASPHALTIC CONCRETE 02. WINDOW OPERATION IS NOT A PERMISSIBLE METHOD OF PROVIDING LAUNDRY EXHAUST FOR HUMIDITY **EMERGENCY** LOW POINT EDGE NAIL ENGINEER **ENERGY EFFICIENCY NOTES** MACH MACHINE WALL SECTION REFERENCE 01. AN ELECTRONICALLY SIGNED AND REGISTERED INSTALLATION CERTIFICATE (S) (CF2R) POSTED BY THE MAINT MAINTENANCE BUILDING SECTION NUMBER EQUIP EQUIPMEN INSTALLING CONTRACTOR SHALL BE SUBMITTED TO THE FIELD INSPECTOR DURING CONSTRUCTION AT THE BUILDING SITE. A REGISTERED CF2R WILL HAVE A UNIQUE 21-DIGIT REGISTRATION NUMBER FOLLOWED BY FOUR SECTION IS DRAWN ZEROS LOCATED AT THE BOTTOM OF EACH PAGE. THE FIRST 12 DIGITS OF THE NUMBER WILL MATCH THE MACHINE BOLT REGISTRATION NUMBER OF THE ASSOCIATED CF1R CERTIFICATE OF OCCUPANCY WILL NOT BE ISSUED UNTIL MECH MECHANICAL FASTEN(FR) FORM CF2R IS REVIEWED AND APPROVED. FORCED AIR UNI AP ACCESS PANEL **FURNISHED BY OWNER 12**. An electronically signed and registered certificate (S) of field verification and diagnostic MISC MISCELLANEOUS DETAIL CALLOUT REFERENCE FLOOR DRAIN FINISHED FLOOR TESTING (CF3R) SHALL BE POSTED AT THE BUILDING SITE BY CERTIFIED HERS RATE. A REGISTERED CF3R WILL MOISTURE RESISTANT HAVE A UNIQUE 25-DIGIT REGISTRATION LOCATED AT THE BOTTOM OF EACH PAGE. THE FIRST 20 DIGITS OF THE DETAIL SECTION NUMBER NUMBER WILL MATCH THE REGISTRATION NUMBER OF THE ASSOCIATED CF2R CERTIFICATE OCCUPANCY WILL FLAT HEAD NOT BE ISSUED UNTIL CF3R IS REVIEWED AND APPROVED. FINISH(ED) FIXTURE FLOOR AUTO AUTOMATIC SECTION IS DRAWN **GREEN CODE NOTE** AVG AVERAGE ~----BOARD BETWEEN 01. ALL PLUMBING FIXTURES AND FITTINGS WILL BE WATER CONSERVING AND WILL COMPLY WITH THE 2013 NOT IN CONTRACT FLASH FLASH(ING) FLUOR FLUORESCENT NO/# NUMBER BITUM BITUMINOUS 02. PROVIDE LAVATORY FAUCETS WITH A MAXIMUM FLOW OF 1.5 GALLONS PER MINUTE (GPM) BLDG BUILDING FOC FACE OF CONCRETE 03. PROVIDE KITCHEN FAUCETS WITH A MAXIMUM FLOW OF 1.8 GALLONS PER MINUTES (GPM) FACE OF FINISH ON CENTER BLKG BLOCKING FOM FACE OF MASONRY 04. PROVIDE SHOWER HEADS WITH A MAXIMUM FLOW OF 2.0 GALLONS PER MINUTE (GPM) OUTSIDE DIAMETER FOP FACE OF PLYWOOD FOS FACE OF STUDS BOUNDARY NAILING W/ ROOM FINISHES 05. PROVIDE WATER CLOSET WITH A MAXIMUM FLOW 1.28 GALLONS PER MINUTE (GPM) OWNER FURNISHED CONTRACTOR INSTALLED 06. PER 2013 CGBSC SEC 4.303.1.3.2, WHEN A SHOWER IS SERVED BY MORE THAN ONE SHOWERHEAD, THE FACE OF WALL OPENING COMBINED FLOW RATE OF ALL SHOWERHEAD AND/OR OTHER SHOWER OUTLETS CONTROLLED BY A SINGLE FIREPROOF; FIREPLACE VALVE SHALL NOT EXCEED 2.0 GALLONS PER MINUTE AT 80 PSI, OR THE SHOWER SHALL BE DESIGNED TO ONLY FOOT OR FEET AST IRON; CONTRACTOR P PAINT (NUMBER - SEE FTG FOOTING ALLOW ONE SHOWER OUTLET TO BE IN OPERATION AT A TIME WL-01 CG-01 07. PERMANENT VACUUM BREAKERS SHALL BE INCLUDED WITH ALL NEW HOSE BIBS CAST IN PLACE PEDESTAL CONTROL JOINT; CEILING 08. PER 2013 CGBSC SEC 4.303.0, PLUMBING FIXTURES (WATER CLOSETS AND URINALS) AND FITTINGS (FAUCETS ROOM NAME W/ ROOM # GALVANIZE(D) AND SHOWERHEADS) SHALL BE INSTALLED IN ACCORDANCE WITH THE CALIFORNIA PLUMBING CODE (CPC) AND GENERAL CONTRACTOR CENTER LINE PERP PERPENDICULAR 101 MASTER BEDROOM GLASS / GLAZING PROPERTY LINE 09. PER 2013 CGBSC SEC 4.506.1 MECHANICAL EXHAUST FANS WHICH EXHAUST DIRECTLY FROM BATHROOMS SHALL COMPLY WITH THE FOLLOWING: W/AREA GYP BDGYPSUM BOARD CONCRETE MASONRY UNIT CLEAN/CLEAR OUT POINT OF CONNECTION A. FANS SHALL ENERGY STAR COMPLIANT AND BE DUCTED TO TERMINATE OUTSIDE THE BUILDING HB HOSE BIB HDR HEADER B. UNLESS FUNCTIONING AS A COMPONENT OF A WHOLE HOUSE VENTILATION SYSTEM, FANS MUST BE PRCST PRE-CAST HDWR HARDWARE CONTROLLED BY A HUMIDISTAT WHICH SHALL BE READILY ACCESSIBLE. HUMIDISTAT CONTROLS SHALL BE PREFABPREFABRICATED HOR / HORIZONTAL CONSTRUCTION CAPABLE OF ADJUSTMENT BETWEEN A RELATIVE HUMIDITY RANGES OF 50 TO 80 PERCENT. CONT CONTINUOUS CORR CORRIDOR WINDOW TAG FIXTURE TAG MATERIAL TAG HIGH POINT; HORSEPOWER PSF POUNDS PER SQUARE FOOT 10. AFTER THE BUILDING PERMIT HAS BEEN ISSUED, THE OWNER SHALL BE RESPONSIBLE FOR ANY COSTS HANDRAIL; HOUR POUNDS PER SQUARE INCH INCURRED AS A RESULT OF CHANGES TO THE DESIGN OF THE FIRE SPRINKLER SYSTEM WHICH PRODUCE GPM (101) COUNTERSINK FX-XX — AND A LARGE METER SIZE REQUIREMENT: PTDF PRESSURE TREATED DOUGLAS FIR DEMO DEMOLISH; DEMOLITION HVAC HEATING / VENTILATION / AIR CONDITIONING **EQUIPMENT** PLUMBING CEILING TAG OWNER SIGNATURE: HW (R) HOT WATER (RETURN) QUARRY TILF INSIDE DIAMÈTER 12. THE MATERIAL AND METHODS OF CONTRUCTION USED FOR THE STRUCTURE, INCLUDING ATTACHED $\bigcirc$ X INCH / INCHES ACCESSORY BUILDINGS (E.G.; GARAGES) AND STRUCTURES (E.G.; PATIO COVERS) SHALL BE IN ACCORDANCE INCLUDE(D) / INCLUDING RADIUS INSUL INSULATE / INSULATION WITH CRC SECTION R327, AS ADOPTED AND AMENDED BY THE CITY OF SAN DIEGO [SDMC 149.0327(A); 55.5001]. 13. 1 1/2" METER HANDLES 41 TO 80 GPM 14. WATER METER FOR COMBINED DOMESTIC WATER AND FIRE SPRINKLER SYSTEM SHALL NOT BE INSTALLED

**VICINITY MAP** 

SITE

**AREA MAP** 

UNTIL THE FIRE SPRINKLER SYSTEM HAS BEEN SUBMITTED AND APPROVED BY THE BUILDING OFFICIAL.

WITHIN ONE FOOT OF THE MAXIMUM HEIGHT ALLOWED IN THE COASTAL HEIGHT LIMIT OVERLAY ZONE

HAVE ANY QUESTIONS PERTAINING TO THE PRE-CONSTRUCTION INSPECTION

DELIVERED TO THE BUILDING OWNER PRIOR TO FINAL INSPECTION.

AND OTHER TOXIC COMPOUNDS AS SPECIFIED IN SECTION 4.504.2.3

(PROPOSITION D). THE PRECONSTRUCTION INSPECTION MUST BE SCHEDULE AND CLEARED BY THE FIELD

INSPECTOR BEFORE ANY SUBSEQUENT INSPECTIONS CAN BE SCHEDULED. CALL (885) 581-7111 TO SCHEDULE

THE PRE-CONSTRUCTION INSPECTION. CONTACT THE INSPECTION SERVICES OFFICE AT (858) 492-5070, IF YOU

**GREEN BUILDING** 

01. AUTOMATIC IRRIGATION SYSTEMS CONTROLLERS INSTALLED AT THE TIME OF FINAL INSPECTION SHALL BE

02. JOINTS AND OPENINGS, ANNULAR SPACES AROUND PIPES, ELECTRICAL CABLES, CONDUITS, OR OTHER

OPENINGS IN PLATES AT EXTERIOR WALLS SHALL BE PROTECTED AGAINST THE PASSAGE OF RODENTS BY

CLOSING SUCH OPENINGS WITH CEMENT MORTAR, CONCRETE MASONRY OR SIMILAR METHOD ACCEPTABLE TO

03. BEFORE FINAL INSPECTION, A COMPLETE OPERATION AND MAINTENANCE MANUAL SHALL BE PROVIDED TO

THE BUILDING OCCUPANT OR OWNER. CONTRACTOR OR OWNER SHALL SUBMIT AN AFFIDAVIT THAT CONFIRMS

04. A COPY OF COMPLETE OPERATION AND MAINTENANCE MANUAL AS OUTLINED IN THE NOTES ABOVE WILL BE

05. AN OWNER MANUAL CERTIFICATION SHOULD BE COMPLETED AND SIGNED BY EITHER A LICENSED GENERAL CONTRACTOR OR A HOME OWNER CERTIFYING THAT A COPY OF THE MANUAL HAS BEEN DELIVERED/RECEIVES

06. DUCT OPENINGS AND OTHER RELATE AIR DISTRIBUTION COMPONENT OPENINGS SHALL BE COVERED

07. ADHESIVES, SEALANTS AND CAULKS SHALL BE COMPLIANT WITH VOC AND OTHER TOXIC COMPOUND LIMIT

08. PAINTS, STAINS AND OTHER COATINGS SHALL BE COMPLIANT WITH PRODUCT WEIGHTED MIR LIMITS OR VOC

09. AEROSOL PAINTS AND COATING SHALL BE COMPLAINT WITH PRODUCT WEIGHTED MIR LIMITS FOR VOC AND OTHER TOXIC COMPOUNDS AS SPECIFIED IN SECTION 4.504.3.2 OF THE CALIFORNIA GREEN BUILDING CODE

PROPOSITION D NOTES

01. THE HIGHEST POINT OF THE ROOF, EQUIPMENT, OR ANY VENT, PIPE, ANTENNA OR OTHER PROJECTIONS

02. A PRE-CONSTRUCTION INSPECTION IS REQUIRED DUE TO THE HEIGHT OF THE PROPOSED STRUCTURE BEING

15. RESPONSIBLE PARTY WATER & SEWER PAYMENT XXX

SHALL NOT EXCEED 30 FEET ABOVE GRADE.

WEATHER-BASED (SECTION 4.304.1

THE DELIVERY OF SUCH. SECTION 4.410.1

DURING CONSTRUCTION (SECTION 4.504.1)

#### ALL WORK SHALL COMPLY WITH THE LATEST EDITION OF THE FOLLOWING CODES AND STANDARS, AS ADOPTED BY THE GOVERNING AUTHORITIES 2016 CALIFORNIA ADMINISTRATIVE CODE 2016 CALIFORNIA BUILDING CODE 2016 CALIFORNIA RESIDENTIAL CODE 2016 CALIFORNIA ELECTRIC CODE 2016 CALIFORNIA MECHANICAL CODE 2016 CALIFORNIA PLUMBING CODE 2016 CALIFORNIA ENERGY CODE (EFFECTIVE 7/1/14) 2016 CALIFORNIA HISTORIC BUILDING CODE 2016 CALIFORNIA FIRE CODE 2016 CALIFORNIA EXISTING BUILDING CODE 2016 CALIFORNIA GREEN BUILDING CODE 2016 CALIFORNIA REFERENCED STANDARDS CODE CALIFORNIA BUILDING CODE NOTE THESE PLANS AND ALL WORK SHALL COMPLY WITH THE 2016 CALIFORNIA RESIDENTIAL CODE 2016 (CRC) & ASSOCIATED AMENDMENTS IN SAN DIEGO MUNICIPAL CODE (SDMC) & 2016 CALIFORNIA BUILDING CODE WICH IS BASED ON THE 2016 IBC FOT THE NON CONVENTIONAL FRAMING STRUCTURAL PROVITIONS, INCLUDING THE 2016 CAL GREEN AND THE 2016 CALIFORNIA ENERGY CODE. **LEGAL DESCRIPTION** PARCEL 1 OF PARCEL MAP NO. 3359, IN THE CITY OF SAN DIEGO, COUNTY OF SAN DIEGO, STATE OF CALIFORNIA, ACCORDING TO MAP THEREOF, FILED IN THE OFFICE OF THE COUNTY RECORDER OF SAN DIEGO COUNTY, DECEMBER 30, 1974. APN #352-141-0100 **DIRECTORY PROJECT DESIGNER** MMK Management Group, LLC Jess Gonzales (619) 292-5520 7455 Hillside Dr. P.O. BOX 84180 SAN DIEGO CA. 92138 La Jolla, CA 92037 STRUCTURAL ENGINEER: Envision Engineering, Inc. 565 Pearl st. ste. 209 La Jolla, CA. 92037 ph. (858) 246 7745 **CIVIL ENGINEER:** Sol Engineering (PH) 619 270.8539. 2127 Olympic Parkway, Suit 1006-320 LANDSCAPE ARCH Sean Clarke, LLA S.R. Clarke Landscape Architecture & Development 110 Copperwood Way #P, Oceanside, CA 92058 LLA#5299 P: (760) 716-3100 Cristopher C. O'Hern TerraPacific Consultants Inc. 4010 Morena Blvd. Ste. 108 San Diego, CA 92117 (PH) 858-521-1190 PROJECT INFORMATION ADDRESS: 7595 HILLSIDE DR. LA JOLLA, CA 92037 LOT SIZE : 0.81 acres 35,415 s.f. (E) USE : SINGLE FAMILIY RESIDENCE (N) USE: CONSTRUCTION TYPE: VB, NON RATED, SPRINKLED OCCUPANCY CLASSIFICATION: R3 **BUILDING AREA:** 2 STORIES (N) BASEMENT FLOOR 610.00 s.f. EXEMPT 3,374.00 s.f. DECK 1,530.00 s.f. MAIN FLOOR 2,187.00s.f. EXEMPT 1,488.00 s.f. BALCONY 1,366.00 s.f.

585.00 s.f. EXEMPT 146.00 s.f.

**TOTAL** 3,382.00 s.f. TOTAL EXEMPT 5,008.00 s.f.

LA JOLLA PLANED DISTRICT

(E) 24,287.04 SF (N) 1,855.34 SF

30'-0" PER PROP-D

1 RESIDENTIAL UNIT

LA JOLLA

**OVERALL BUILDING HEIGHT:** 30'-0" PER SECTIONS

COVENANT OF EASEMENT (COE) AREA: 9,638.04 SF

GARAGE

**BUILDING YEAR:** 

**COMMUNITY PLAN:** 

PLANED DISTRICT:

MAX BUILDING HEIGHT:

LANDSCAPING AREA:

**FAR**: 8,575.00 / 34,735.72 = 24%

**GEOLOGIC HAZARD CATEGORIES: 27** 

BASE ZONE :

**DENSITY:** 

SPRINKLED:

CODE COMPLIANCE

**ARCHITECTURAL** DS-01 DSD 560 - SWQMP D-01 DEMOLITION PLAN A-01 SITE PLAN MATERIALS AND TRAFFIC CONTROL EXHIBIT A-01.1 A-02 **GROUND LEVEL** A-03 MAIN LEVEL A-04 **ROOF LEVEL** A-05 SECTIONS 01 (A - B) A-05.1 SECTIONS 02 (C - D) A-05.2 SECTIONS 03 (E - F) A-05.3 SECTIONS 04 (G) A-05.4 SECTIONS S1 - S7 A-06 **ELEVATION N - S** A-06.1 **ELEVATION E - W** LANDSCAPE: L-1 PLANTING SPECIFICATIONS TP L1 - 3 LANDSCAPE PLAN L2 - 3 **BRUSH MANAGEMENT PLAN** L3 - 3 LANDSCAPE AREA DIAGRAM CIVIL: C-1 DRAINAGE BMP PLAN DRAINAGE BMP PLAN C-2 FIRE: F.01

SHEET INDEX

TITLE PAGE

GENERAL:


T-01

**SCOPE OF WORK** 

NEW SINGLE FAMILY RESIDENCE TO BE BUILT ON A LOT SITUATED AT 7595 HILLSIDE DRIVE, SAN DIEGO, CA 92037-3943, HOUSE WILL BE A 5 BEDROOM HOME, PLUS BASEMENT, 3 CAR GARAGE AND POOL.

**DEFERRED ITEMS** 

SCALE: 1" = 10'

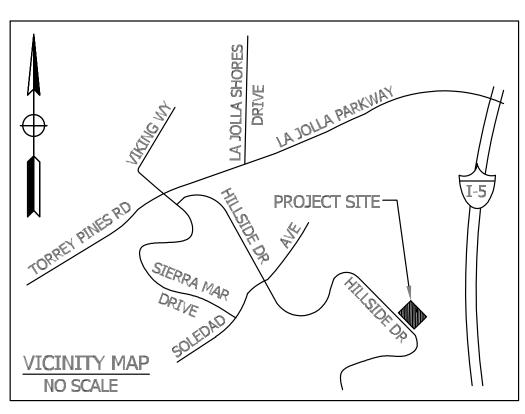

#### **VICINTY MAP** NO SCALE

#### SHEET INDEX:

C-1 - GRADING & DRAINAGE PLAN C-2 - BMP PLAN

#### **BENCHMARK:**

THE BENCHMARK USED FOR THIS SURVEY WAS OBTAINED FROM CITY OF SAN DIEGO BENCHMARK BOOK

HILLSIDE DRIVE & SOLEDAD AVE SW BRASS PLUG

ELEVATION: 228.995 MSL

## **LEGAL DESCRIPTION:**

PARCEL 1 OF PARCEL MAP NO. 3359, IN THE CITY OF SAN DIEGO, COUNTY OF SAN DIEGO, STATE OF CALIFORNIA, ACCORDING TO MAP THEREOF, FILED IN THE OFFICE OF THE COUNTY RECORDER OF SAN DIEGO COUNTY, DECEMBER 30, 1974.

## **BASIS OF BEARINGS:**

THE BASIS OF BEARINGS FOR THIS SURVEY WAS OBTAINED FROM WESTERLY LINE OF PARCEL 1 AS SHOWN ON MAP I.E. N57'49'56"E

## FEMA FLOOD ZONE:

SUBJECT PROPERTY IS LOCATED WITHIN ZONE X. MINIMAL FLOOD HAZARD

#### TOPOGRAPHIC SURVEY:

AERIAL AND FILED SURVEY PERFORMED BY SOL ENGINEERING

#### **ZONING:**

EXISTING: R-1 SINGLE PROPOSED: R-1 SINGLE

#### **PROPERTY OWNER:**

MMK MANAGEMENT GROUP, LLC 7455 HILLSIDE DR. LA JOLLA, CA 92037

## **PROJECT ADDRESS:**

7595 HILLSIDE DR. LA JOLLA, CA 92037

## APN:

SITE AREA:

APN: 352-141-01-00

0.79 ACRES (34,412 SQUARE FEET)

#### **GRADING TABULATION:**

AMOUNT OF EXPORT OF SOIL: 2,000 CY APPROX. RETAINING WALLS: 150 LF MAX HEIGHT 11'

AMOUNT OF SITE AREA TO BE GRADED: % OF TOTAL SITE: AMOUNT OF CUT (1.5:1 MAX): 2,000 CY AMOUNT OF FILL: (2:1 MIN) 0.0 CY HEIGHT OF CUT/FILL (UNDER BLDG.): CUT: 23.5' MAX, FILL: 4.9' MAX. HEIGHT OF CUT/FILL (OUTSIDE BLDG.): CUT: 18' MAX, FILL: O' MAX.

## IMPERVIOUS DATA TABLE:

TOTAL DISTURBANCE AREA 8,100 SF EXISTING AMOUNT OF PERVIOUS AREA PROPOSED AMOUNT OF PERVIOUS AREA 27,779 SF EXISTING AMOUNT OF IMPERVIOUS AREA 4,415 SF PROPOSED AMOUNT OF IMPERVIOUS AREA 7.133 SF 7,133F 62 % TOTAL IMPERVIOUS AREA IMPERVIOUS % INCREASE

### CERTIFICATION AND DECLARATION OF RESPONSIBLE CHARGE

1. I HEREBY DECLARE THAT I AM THE ENGINEER FOR THIS PROJECT, THAT I HAVE EXERCISED RESPONSIBLE CHARGE OVER THIS SUBMITTAL AS DEFINED IN SECTION 6703 OF THE BUSINESS AND PROFESSIONS CODE. 2. I CERTIFY THAT I HAVE PERFORMED REASONABLE RESEARCH TO DETERMINE THE REQUIRED APPROVALS FOR THE PROPOSED PROJECT.

## **ENGINEER OF WORK**


JOSE L. SANCHEZ R.C.E. 86435 EXP. 3-31-21

**CIVIL ENGINEERING - WATER RESOURCES** 

**PLANNING** Tel. 619-227-8941 2371 Fenton Street, Suite 100 Chula Vista. CA 91914

DATE



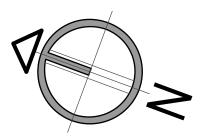

NORTH

2nd review - 5.19.2020 3rd review - 5.28.2020 4th review - 10.14.2020

DATE. 12.15.2020

CITY SUBMITTAL SAN DIEGO SCALE. INDICATE IN DRAW DRAW.

JOB NO.

E.M.

SHEET TITLE:

DRAINAGE/BM P PLAN

**C**-1

329.4FS

330.3FS -

HILLSIDE DR

- 328.7FS

DRIVEWAY DETAIL

SCALE: 1" = 5'

10.0'


- PROPOSED

GUTTER

SCALE: 1" = 5

CURB AND

- 331.0FS

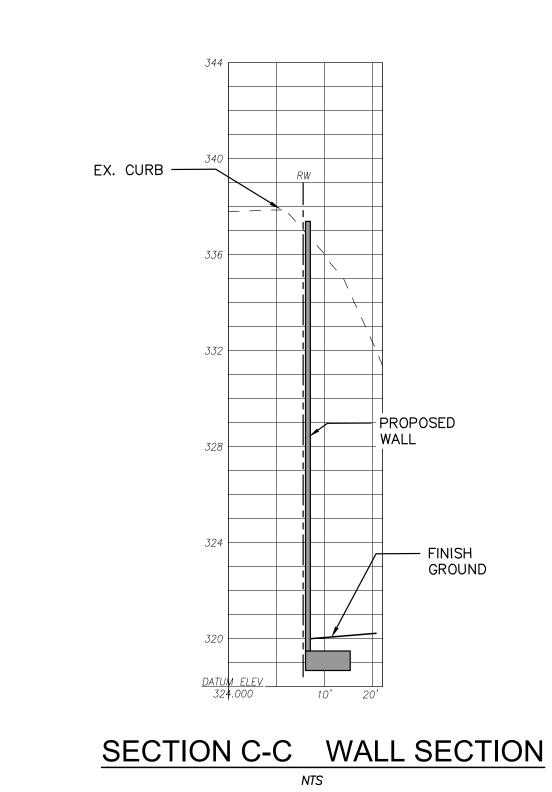


PROPOSED

— FINISH


GROUND

WALL

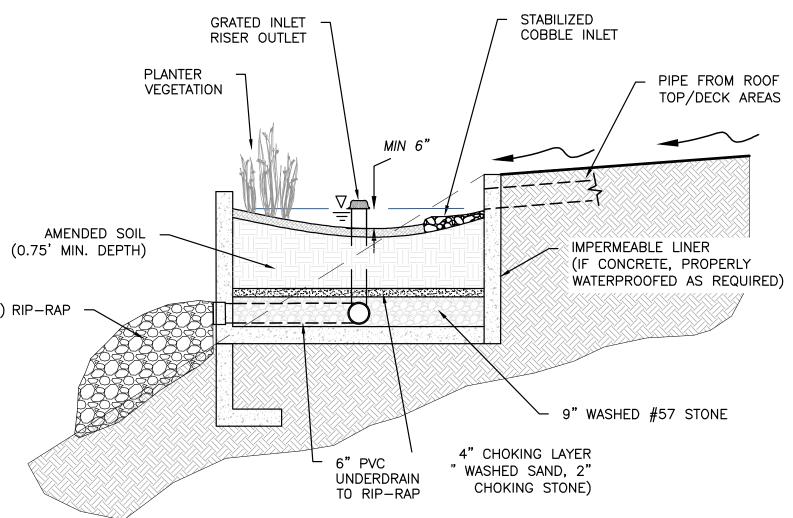

## **SECTION A - PLANTER SECTION**

NTS

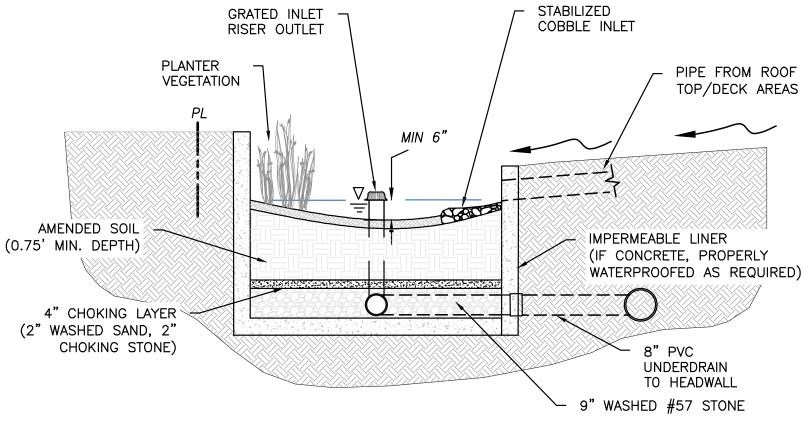

## **SECTION B - PLANTER SECTION**

## POST CONSTRUCTION BMP LEGEND

## POST-CONSTRUCTION BMPS

DOWNSPOUT TO PLANTER

THIS PROJECT PROPOSES POST-CONSTRUCTION BEST MANAGEMENT PRACTICES AND LID MEASURES REQUIRED UNDER THE CITY OF SAN DIEGO STORM WATER MANAGEMENT, AND DISCHARGE CONTROL ORDINANCE (SECTION 43.03).

#### LOW IMPACT/SITE DESIGN BMPS

- IMPERVIOUS AREA DISPERSION (SD-5)
  THE PROJECT DRAINS ROOF TOP RUNOFF INTO CLOSE BY LAWN AREAS WITH A MINIMUM LENGTH OF 10' AND MAXIMUM GRADE OF
- DISPERSE RUNOFF TO ADJACENT LANDSCAPING
  THE PROJECT DRAINS WALKWAYS, PATIOS AND DECKS INTO ADJACENT LANDSCAPED AREAS.


#### SOURCE CONTROL BMPS

- EMPLOY INTEGRATED PEST MANAGEMENT PRINCIPLES (SC-6)
  IPM EDUCATIONAL MATERIALS SHOULD BE DISTRIBUTED TO FUTURE
  SITE RESIDENTS AND TENANTS. THESE EDUCATIONAL MATERIALS SHOULD ADDRESS THE FOLLOWING:
- USE OF BARRIERS, SCREENS, AND CAULKING TO KEEP PESTS OUT OF BUILDINGS AND LANDSCAPING.
- a. PHYSICAL PEST ELIMINATION TECHNIQUES, SUCH AS WEEDING, WASHING, OR TRAPPING PESTS. b. RELYING ON NATURAL ENEMIES TO ELIMINATE PESTS.c. PROPER USE OF PESTICIDES AS A LAST LINE OF DEFENSE.
- USE NON-TOXIC ROOFING MATERIALS WHERE FEASIBLE:

THE PROJECT WILL AVOID THE USE OF GALVANIZED STEEL OR COPPER FOR ROOFS, GUTTERS, AND DOWNSPOUTS. THE PROJECT WILL AVOID COMPOSITE ROOFING MATERIALS THAT CONTAIN COPPER.

**AP**consulting CIVIL ENGINEERING - WATER RESOURCES PLANNING Tel. 619-227-8941 2371 Fenton Street, Suite 100 Chula Vista, CA 91914



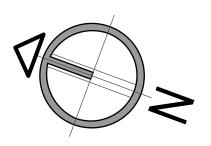

NORTH

2nd review - 5.19.2020 3rd review - 5.28.2020 4th review - 10.14.2020

DATE.

12.15.2020 CITY SUBMITTAL. SAN DIEGO SCALE. INDICATE IN DRAW

DRAW. E.M. JOB NO.

SHEET TITLE:

P PLAN

DRAINAGE/BM

**C-2** 

Project Address: 7595 Hillside Drive 522708 **SECTION 1. Construction Storm Water BMP Requirements:** All construction sites are required to implement construction BMPs in accordance with the performance standards

in the <u>Storm Water Standards Manual</u>. Some sites are additionally required to obtain coverage under the State Construction General Permit (CGP)<sup>1</sup>, which is administered by the State Regional Water Quality Control Board.

## For all projects complete PART A: If project is required to submit a SWPPP or WPCP, continue to PART B.

#### PART A: Determine Construction Phase Storm Water Requirements.

. Is the project subject to California's statewide General NPDES permit for Storm Water Discharges Associated with Construction Activities, also known as the State Construction General Permit (CGP)? (Typically projects with land disturbance greater than or equal to 1 acre.)

#### Yes; SWPPP required, skip questions 2-4 No; next question

2. Does the project propose construction or demolition activity, including but not limited to, clearing, grading, grubbing, excavation, or any other activity resulting in ground disturbance and/or contact with storm water?

#### Yes; WPCP required, skip questions 3-4 No; next question

3. Does the project propose routine maintenance to maintain original line and grade, hydraulic capacity, or original purpose of the facility? (Projects such as pipeline/utility replacement)

Yes; WPCP required, skip question 4 No; next question

#### 4. Does the project only include the following Permit types listed below? Electrical Permit, Fire Alarm Permit, Fire Sprinkler Permit, Plumbing Permit, Sign Permit, Mechanical Permit,

- Individual Right of Way Permits that exclusively include only ONE of the following activities: water service,
- Right of Way Permits with a project footprint less than 150 linear feet that exclusively include only ONE of the following activities: curb ramp, sidewalk and driveway apron replacement, pot holing, curb and gutter replacement, and retaining wall encroachments.

#### Yes; no document required

Check one of the boxes below, and continue to PART B:

## If you checked "Yes" for question 1, a SWPPP is REQUIRED. Continue to PART B

If you checked "No" for question 1, and checked "Yes" for question 2 or 3, a WPCP is REQUIRED. If the project proposes less than 5,000 square feet of ground disturbance AND has less than a 5-foot elevation change over the entire project area, a Minor WPCP may be required instead. Continue to PART B.

## If you checked "No" for all questions 1-3, and checked "Yes" for question 4 PART B does not apply and no document is required. Continue to Section 2.

More information on the City's construction BMP requirements as well as CGP requirements can be found at:

rinted on recycled paper. Visit our web site at <a href="https://www.sandiego.gov/development-services">www.sandiego.gov/development-services</a> Upon request, this information is available in alternative formats for persons with disabilities. Page 2 of 4 City of San Diego • Development Services • Storm Water Requirements Applicability Checklist

#### **PART B: Determine Construction Site Priority**

This prioritization must be completed within this form, noted on the plans, and included in the SWPPP or WPCP. The city reserves the right to adjust the priority of projects both before and after construction. Construction projects are assigned an inspection frequency based on if the project has a "high threat to water quality." The City has aligned the local definition of "high threat to water quality" to the risk determination approach of the State Construction General Permit (CGP). The CGP determines risk level based on project specific sediment risk and receiving water risk. Additional inspection is required for projects within the Areas of Special Biological Significance (ASBS) watershed. **NOTE:** The construction priority does **NOT** change construction BMP requirements that apply to projects; rather, it determines the frequency of inspections that will be conducted by city staff.

#### Complete PART B and continued to Section 2

1.		ASBS
		a. Projects located in the ASBS watershed.
	_	

**SECTION 2. Permanent Storm Water BMP Requirements.** 

- High Priority a. Projects that qualify as Risk Level 2 or Risk Level 3 per the Construction General Permit (CGP) and not located in the ASBS watershed.
- Medium Priority
  - a. Projects that are not located in an ASBS watershed or designated as a High priority site. b. Projects that qualify as Risk Level 1 or LUP Type 1 per the CGP and not located in an ASBS

b. Projects that qualify as LUP Type 2 or LUP Type 3 per the CGP and not located in the ASBS

c. WPCP projects (>5,000sf of ground disturbance) located within the Los Penasquitos watershed management area.

## a. Projects not subject to a Medium or High site priority designation and are not located in an ASBS

Low Priority

Additional information for determining the requirements is found in the Storm Water Standards Manual.

#### PART C: Determine if Not Subject to Permanent Storm Water Requirements. Projects that are considered maintenance, or otherwise not categorized as "new development projects" or "redevelopment projects" according to the <u>Storm Water Standards Manual</u> are not subject to Permanent Storm Water

If "yes" is checked for any number in Part C, proceed to Part F and check "Not Subject to Permanent Storm Water BMP Requirements".

lf'	no" is checked for all of the numbers in Part C continue to Part D.			
1.	Does the project only include interior remodels and/or is the project entirely within an existing enclosed structure and does not have the potential to contact storm water?	☐ Yes 🗷		
2.	Does the project only include the construction of overhead or underground utilities without creating new impervious surfaces?	☐ Yes 🗵		
2	Does the project fall under routine maintenance? Examples include but are not limited to:			

roof or exterior structure surface replacement, resurfacing or reconfiguring surface parking lots or existing roadways without expanding the impervious footprint, and routine replacement of damaged pavement (grinding, overlay, and pothole repair).

☐ Yes ☒ No

## Page 3 of 4 City of San Diego • Development Services • Storm Water Requirements Applicability Checklist

☐ Yes 区No

#### **PART D: PDP Exempt Requirements.**

PDP Exempt projects are required to implement site design and source control BMPs.

## If "yes" was checked for any questions in Part D, continue to Part F and check the box labeled

- If "no" was checked for all questions in Part D, continue to Part E.
- 1. Does the project ONLY include new or retrofit sidewalks, bicycle lanes, or trails that: • Are designed and constructed to direct storm water runoff to adjacent vegetated areas, or other
- non-erodible permeable areas? Or;
- Are designed and constructed to be hydraulically disconnected from paved streets and roads? Or; • Are designed and constructed with permeable pavements or surfaces in accordance with the Green Streets guidance in the City's Storm Water Standards manual?
- Yes; PDP exempt requirements apply No; next guestion
- Does the project ONLY include retrofitting or redeveloping existing paved alleys, streets or roads designed and constructed in accordance with the Green Streets guidance in the <u>City's Storm Water Standards Manual</u>?

## Yes; PDP exempt requirements apply No; project not exempt.

PART E: Determine if Project is a Priority Development Project (PDP). Projects that match one of the definitions below are subject to additional requirements including preparation of a Storm Water Quality Management Plan (SWQMP).

#### If "yes" is checked for any number in PART E, continue to PART F and check the box labeled "Priority Development Project".

#### If "no" is checked for every number in PART E, continue to PART F and check the box labeled "Standard Development Project".

- New Development that creates 10,000 square feet or more of impervious surfaces collectively over the project site. This includes commercial, industrial, residential, □Yes 🗵 No mixed-use, and public development projects on public or private land.
- Redevelopment project that creates and/or replaces 5,000 square feet or more of impervious surfaces on an existing site of 10,000 square feet or more of impervious surfaces. This includes commercial, industrial, residential, mixed-use, and public development projects on public or private land. □Yes ⊠No
- **New development or redevelopment of a restaurant.** Facilities that sell prepared foods and drinks for consumption, including stationary lunch counters and refreshment stands selling prepared foods and drinks for immediate consumption (SIC 5812), and where the land 🗌 Yes 🗵 No development creates and/or replace 5,000 square feet or more of impervious surface.
- **New development or redevelopment on a hillside.** The project creates and/or replaces 5,000 square feet or more of impervious surface (collectively over the project site) and where the development will grade on any natural slope that is twenty-five percent or greater.
- New development or redevelopment of a parking lot that creates and/or replaces 5,000 square feet or more of impervious surface (collectively over the project site). □Yes ⊠No
- New development or redevelopment of streets, roads, highways, freeways, and **driveways.** The project creates and/or replaces 5,000 square feet or more of impervious surface (collectively over the project site).

#### Page 4 of 4 City of San Diego • Development Services • Storm Water Requirements Applicability Checklist

New development or redevelopment discharging directly to an Environmentally Sensitive Area. The project creates and/or replaces 2,500 square feet of impervious surface (collectively over project site), and discharges directly to an Environmentally Sensitive Area (ESA). "Discharging directly to" includes flow that is conveyed overland a distance of 200 feet or less from the project to the ESA, or conveyed in a pipe or open channel any distance as an isolated flow from the project to the ESA (i.e. not commingled with flows from adjacent

☐ Yes ☒ No

#### New development or redevelopment projects of a retail gasoline outlet (RGO) that create and/or replaces 5,000 square feet of impervious surface. The development project meets the following criteria: (a) 5,000 square feet or more or (b) has a projected Average Daily Traffic (ADT) of 100 or more vehicles per day.

New development or redevelopment projects of an automotive repair shops that creates and/or replaces 5,000 square feet or more of impervious surfaces. Development projects categorized in any one of Standard Industrial Classification (SIC) codes 5013, 5014, 5541, 7532-7534, or 7536-7539.

☐ Yes 区 No

D. Other Pollutant Generating Project. The project is not covered in the categories above, results in the disturbance of one or more acres of land and is expected to generate pollutants post construction, such as fertilizers and pesticides. This does not include projects creating less than 5,000 sf of impervious surface and where added landscaping does not require regular use of pesticides and fertilizers, such as slope stabilization using native plants. Calculation of the square footage of impervious surface need not include linear pathways that are for infrequent vehicle use, such as emergency maintenance access or bicycle pedestrian use, if they are built with pervious surfaces of if they sheet flow to surrounding pervious surfaces.

#### PART F: Select the appropriate category based on the outcomes of PART C through PART E.

1.	The project is <b>NOT SUBJECT TO PERMANENT STORM WATER REQUIREMENTS</b> .	
2.	The project is a <b>STANDARD DEVELOPMENT PROJECT</b> . Site design and source control BMP requirements apply. See the <u>Storm Water Standards Manual</u> for guidance.	×
3.	The project is <b>PDP EXEMPT</b> . Site design and source control BMP requirements apply. See the Storm Water Standards Manual for guidance.	

The project is a **PRIORITY DEVELOPMENT PROJECT**. Site design, source control, and structural pollutant control BMP requirements apply. See the Storm Water Standards Manual for guidance on determining if project requires a hydromodification plan management

Jess Gonzales Project Manager Name of Owner or Agent (Please Print)

Signature

Standard Development Project Storm Water Quality Management Plan (SWQMP)

#### 7595 Hillside Dr. La Jolla CA 92037

**PTS** 522708

#### **Prepared For:**

MMK Management Group, LLC

#### Prepared By:

AP Consulting Inc

619-227-8941

#### for Standard Projects All development projects must implement source control BMPs. Refer to Chapter 4 and Appendix E of the BMP Design Manual for information to implement BMPs shown in this checklist. Note: All selected BMPs must be shown on the construction plans. Source Control Requirement 4.2.1 Prevention of Illicit Discharges into the MS4 4.2.2 Storm Drain Stenciling or Signage ☐Yes ☐No **X**N/A and Wind Dispersal 1.2.6 BMPs based on Potential Sources of Runoff Pollutants On-site storm drain inlets Interior floor drains and elevator shaft sump pumps Interior parking garages Need for future indoor & structural pest control Landscape/Outdoor Pesticide Use Pools, spas, ponds, decorative fountains, and other water features Food service Refuse areas Industrial processes Outdoor storage of equipment or materials Vehicle/Equipment Repair and Maintenance Fuel Dispensing Areas Loading Docks Fire Sprinkler Test Water Miscellaneous Drain or Wash Water Plazas, sidewalks, and parking lots SC-6A: Large Trash Generating Facilities SC-6B: Animal Facilities SC-6C: Plant Nurseries and Garden Centers SC-6D: Automotive Facilities Discussion / justification for <u>all</u> "No" answers shown above:

Source Control BMP Checklist

4.2.3 Protect Outdoor Materials Storage Areas from Rainfall, Run-On, Runoff, and Wind Dispersal 4.2.4 Protect Materials Stored in Outdoor Work Areas from Rainfall, Run-On, Runoff, and Wind Dispersal 4.2.5 Protect Trash Storage Areas from Rainfall, Run-On, Runoff,

The City of San Diego | Storm Water Standards

Form I-4A | January 2018 Edition

SD


## Site Design BMP Checklist for Standard Projects All development projects must implement site design BMPs. Refer to Chapter 4 and Appendix E of the BMP Design Manual for information to implement BMPs shown in this checklist. Note: All selected BMPs must be shown on the construction plans. Site Design Requirement 4.3.1 Maintain Natural Drainage Pathways and Hydrologic 4.3.2 Conserve Natural Areas, Soils, and Vegetation 4.3.3 Minimize Impervious Area 4.3.4 Minimize Soil Compaction 4.3.5 Impervious Area Dispersion 4.3.6 Runoff Collection 4.3.7 Landscaping with Native or Drought Tolerant Species 4.3.8 Harvest and Use Precipitation Discussion / justification for <u>all</u> "No" answers shown above: (1) Answer for each source control and site design category shall be pursuant to the following: • "Yes" means the project will implement the BMP as described in Chapter 4 and/or Appendix E of the BMP Design Manual. Discussion / justification is not required. • "No" means the BMP is applicable to the project but it is not feasible to implement. Discussion / justification must be provided.

- "N/A" means the BMP is not applicable at the project site because the project does not include the feature that is addressed by the BMP (e.g., the project has no outdoor materials storage areas). Discussion / justification may be provided.

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619.858.2345 F. 619.858.2344 P.O.Box. 84180 San Diego Ca. 92138 office@cdgius.com www.cdgius.com



NORTH 2nd review - 5.19.2020 3rd review - 5.28.2020 4th review - 10.14.2020

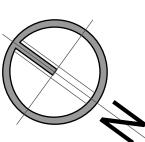DATE. 12.15.2020 CITY SUBMITTAL. SAN DIEGO SCALE. INDICATE IN DRAW DRAW.


SHEET TITLE:

DSD560 -SWQMP

E.M.

JOB NO.

DS.01

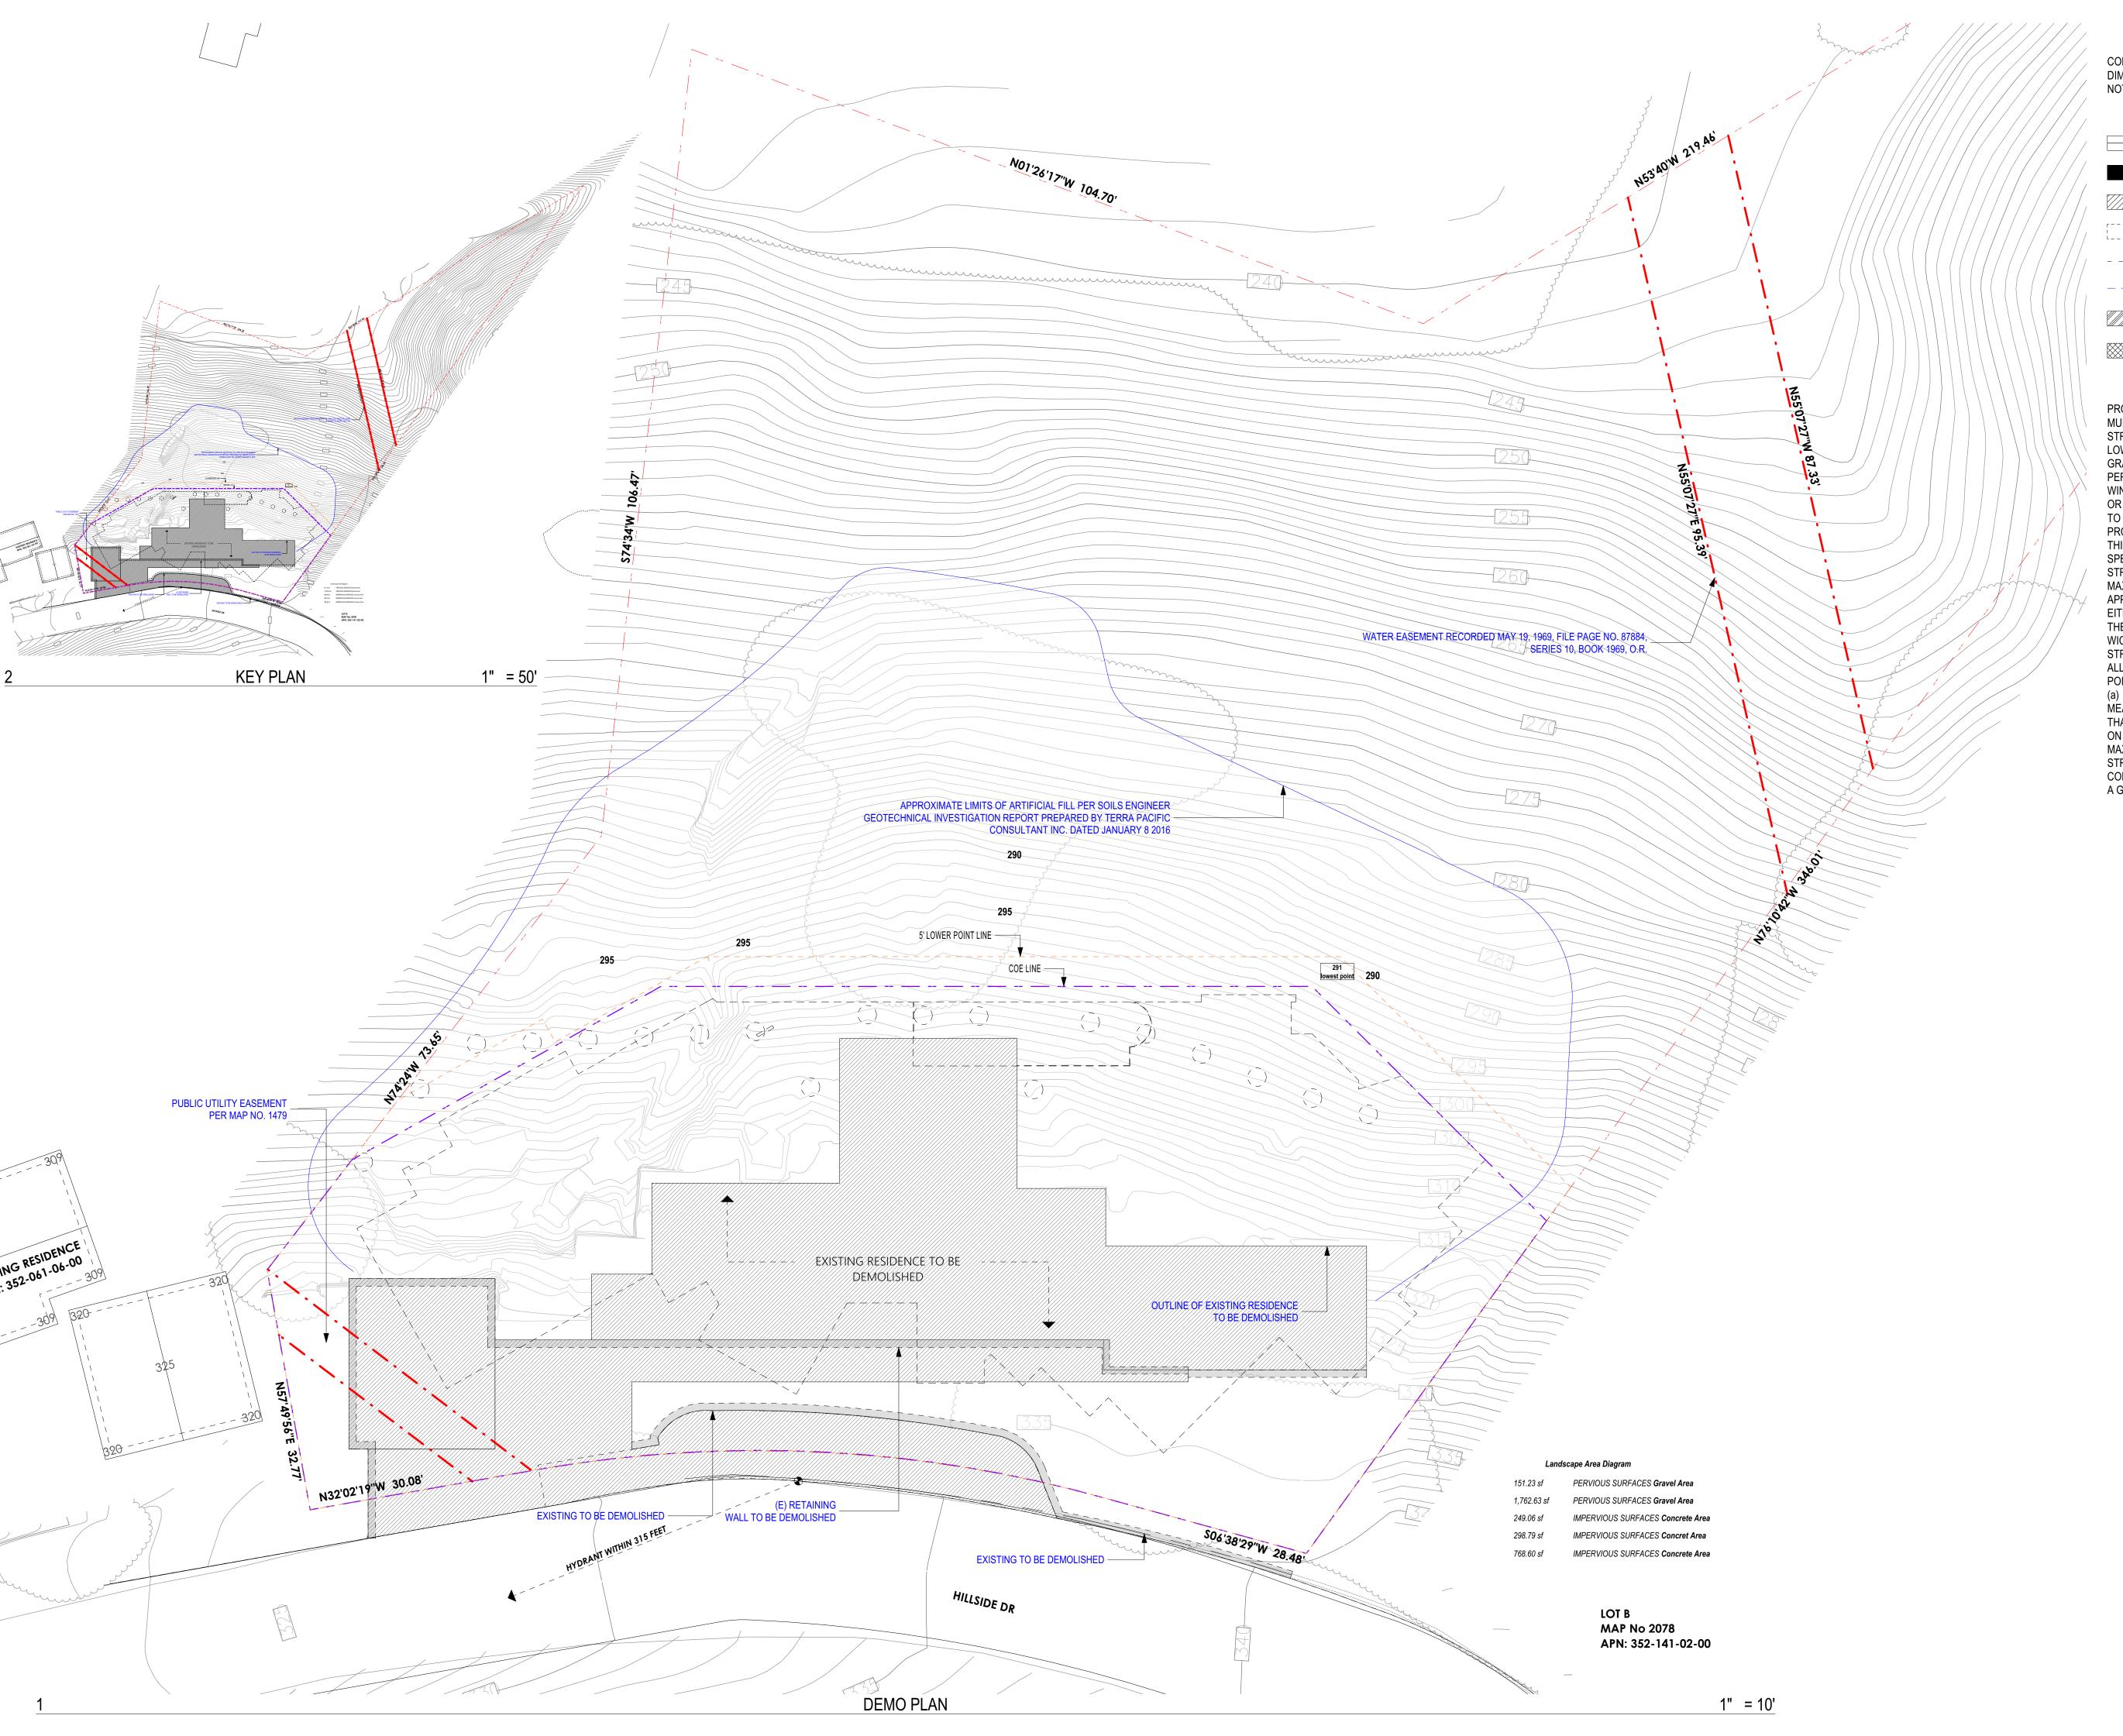

## **CONTRACTOR NOTE**

CONTRACTOR SHALL VERIFY SITE CONDITIONS AND DIMENSIONS PRIOR TO COMMENCEMENT OF WORK NOTIFY ARCHITECT OF ANY DISCREPANCIES.

LEGEND

#### \_\_\_\_

NEW RETAINING WALL

NEW FRAMING WALLS

(E) FRAMING WALLS

EXISTING WALLS TO BE DEMOLISHED

EXISTING RETAINING WALLS

EXISTING GRADE


MAIN FLOOR AREA TO EXEMPT

MAIN FLOOR AREA TO FAR

## **GENERAL NOTES**

PROPOSED BUILDING HEIGHT PER SAN DIEGO MUNICIAL CODE 113.0270 (a) (6); THE OVERALL STRUCTURE HEIGHT IS MEASURED FROM HE LOWEST POINT OF EXISTING GRADE OR PROPOSED GRADE WITHIN 5 FEET OF THE STRUCTURE'S PERIMETER (BUILDING WALL, BALCONY, BAY WINDOW, OR SIMILAR ARCHITECTURAL PROJECTION) OR AT THE PROPERTY LINE WICH EVER IS CLOSER, TO THE HIGEST POINT OF THE STRUCTURE, PROJECTED HORIZONTALLY TO DIRECTLY ABOVE THIS LOWEST POINT OF GRADE, EXCEPT AS SPECIFIED IN SECTION 113.0270 (a) (6) THE OVERALL STRUCTURE HEIGHT SHALL NOT EXCEED THE MAXIMUM PERMITTED STRUCTURE HEIGHT OF THE APPLICABLE ZONE PLUS AN AMOUNT EQUAL TO EITHER THE MAXIMUM GRADE DIFFERENTIAL WITHIN THE STRUCTURE'S FOOTPRINT OR 10 FEET, WICHEVER IS LESS. IN NO CASE MAY THE STRUCTURE HEIGHT EXCEED THE MAXIMUM ALLOWED BY THE APPLICABLE ZONE AT ANY ONE POINT MEASURED PERSUANT TO SECTION 113.0270 (a) (3); 113.0270 (a) (7); STRUCTURE HEIGHT IS MEASSURED SEPARATELY FOR EACH STRUCTURE THAT IS SEPARATED FROM ANOTHER STRUCTURE ON THE PREMISES BY 6 FEET OR MORE. 103.030A (K) MAXIMUM BUILDING HEIGHT: NO BUILDING OR STRUCTURE SHALL BE ERECTED, CONSTRUCTED, ALTERED, MOVED OR ENLARGED TO A GREATER HEIGHT THAN THIRTY (30) FEET.



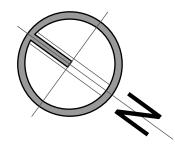

2nd review - 5.19.2020 3rd review - 5.28.2020 4th review - 10.14.2020

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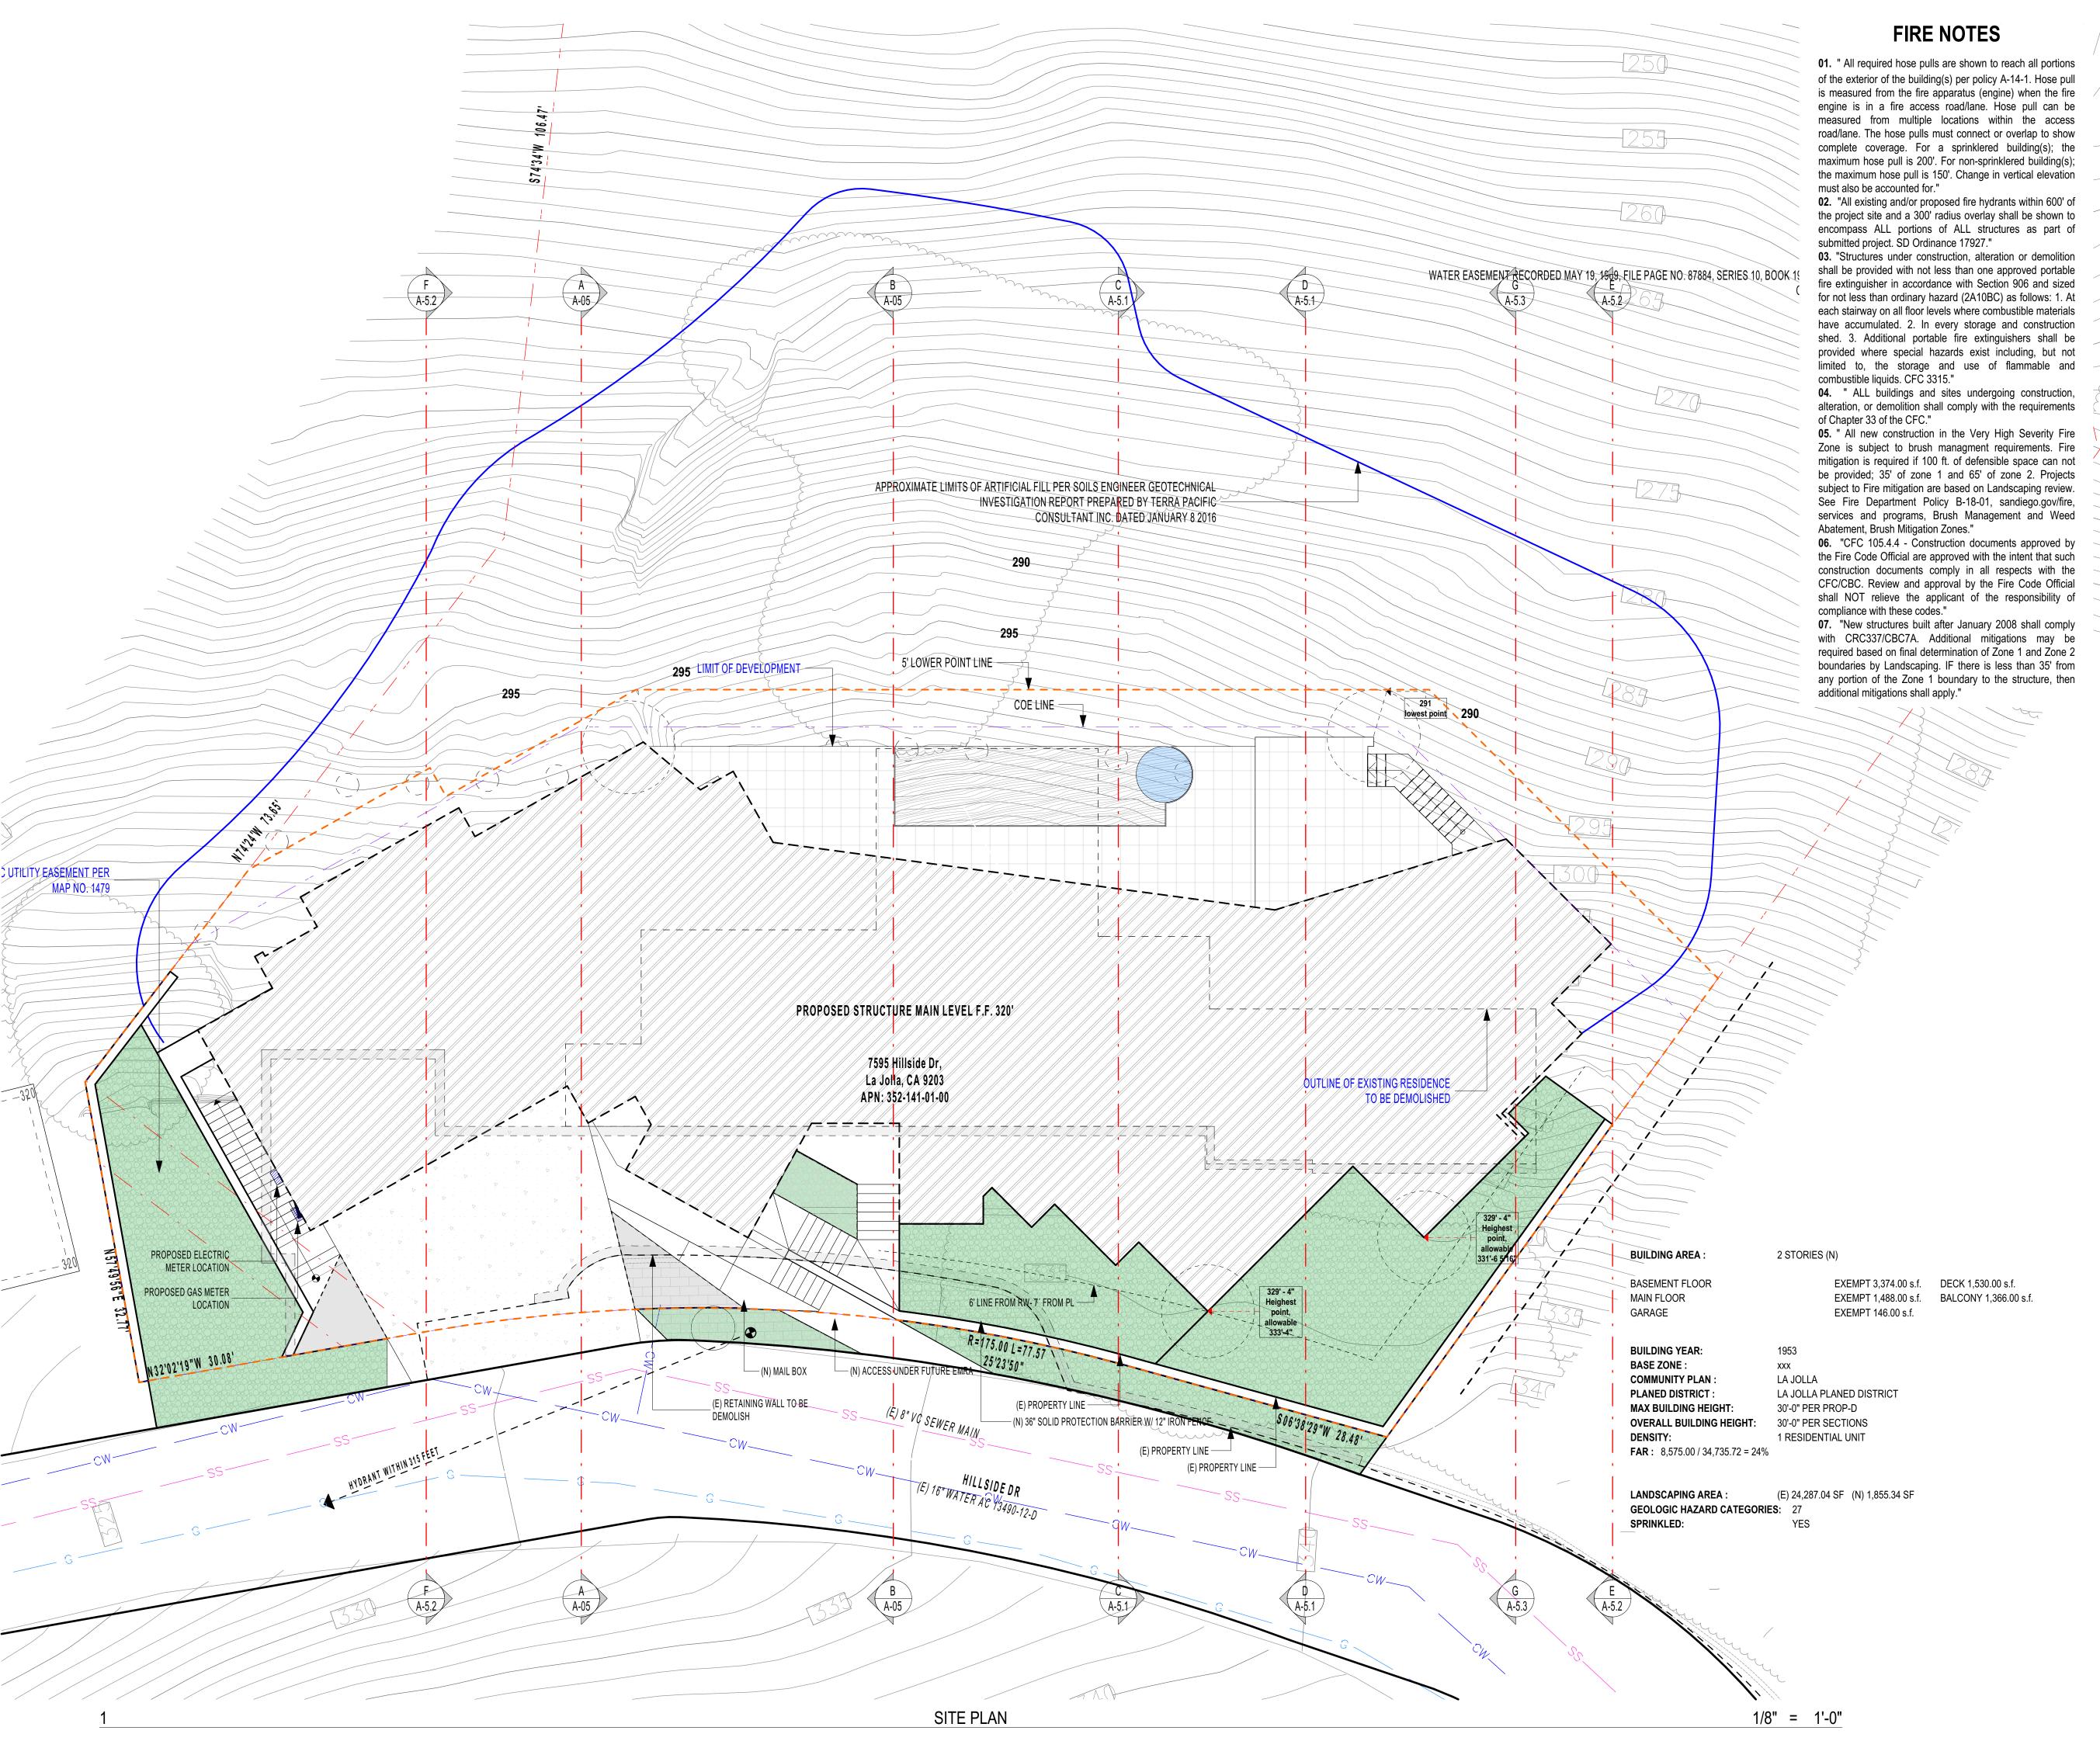
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JOB NO.

SHEET TITLE:

DEMO PLAN

D.01



## **CONTRACTOR NOTE**

CONTRACTOR SHALL VERIFY SITE CONDITIONS AND DIMENSIONS PRIOR TO COMMENCEMENT OF WORK NOTIFY ARCHITECT OF ANY DISCREPANCIES.

## **LEGEND**

NEW RETAINING WALL



-----

**NEW FRAMING WALLS** 



(E) FRAMING WALLS EXISTING WALLS TO BE DEMOLISHED

EXISTING RETAINING WALLS

**EXISTING GRADE** 

MAIN FLOOR AREA TO EXEMPT



MAIN FLOOR AREA TO FAR

## **GENERAL NOTES**

PROPOSED BUILDING HEIGHT PER SAN DIEGO MUNICIAL CODE 113.0270 (a) (6): THE OVERALL STRUCTURE HEIGHT IS MEASURED FROM HE LOWEST POINT OF EXISTING GRADE OR PROPOSED GRADE WITHIN 5 FEET OF THE STRUCTURE'S PERIMETER (BUILDING WALL, BALCONY, BAY WINDOW, OR SIMILAR ARCHITECTURAL PROJECTION) OR AT THE PROPERTY LINE WICH EVER IS CLOSER TO THE HIGEST POINT OF THE STRUCTURE PROJECTED HORIZONTALLY TO DIRECTLY ABOVE THIS LOWEST POINT OF GRADE, EXCEPT AS SPECIFIED IN SECTION 113.0270 (a) (6) THE OVERALL STRUCTURE HEIGHT SHALL NOT EXCEED THE MAXIMUM PERMITTED STRUCTURE HEIGHT OF THE APPLICABLE ZONE PLUS AN AMOUNT EQUAL TO EITHER THE MAXIMUM GRADE DIFFERENTIAL WITHIN THE STRUCTURE'S FOOTPRINT OR 10 FEET, WICHEVER IS LESS. IN NO CASE MAY THE STRUCTURE HEIGHT EXCEED THE MAXIMUM ALLOWED BY THE APPLICABLE ZONE AT ANY ONE POINT MEASURED PERSUANT TO SECTION 113.0270 (a) (3); 113.0270 (a) (7); STRUCTURE HEIGHT IS MEASSURED SEPARATELY FOR EACH STRUCTURE THAT IS SEPARATED FROM ANOTHER STRUCTURE ON THE PREMISES BY 6 FEET OR MORE. 103.030A (K) MAXIMUM BUILDING HEIGHT: NO BUILDING OR STRUCTURE SHALL BE ERECTED, CONSTRUCTED, ALTERED, MOVED OR ENLARGED TO A GREATER HEIGHT THAN THIRTY (30) FEET.

#### **NEW NOTES**

01. SEE SHEET C-1 (GRADING & DRAINAGE) FOR ALL EXISTING AND PROPOSED UTILITIES ON THE SITE OR IN THE ADJACENT RIGHT OF WAY.

02. PROVIDE BUILDING ADDRESS NUMBER VISIBLE AND LEGIBLE FROM THE STREET OR ROAD FRONTING THE PROPERTY PER FHPS POLICY P-00-6. **03.** NO EXISTING BUS STOP.

**04.** FIRE HYDRANTS WITHIN 315 FEET. **05. DECK NOTE:** IGNITION-RESISTANT MATERIALS THAT COMPLIES WITH THE PERFORMANCE

REQUIREMENTS OF BOTH SFM STANDARD 12-7A-4 ANS SFM STANDARD 12-7A-5. 06. AN EMRA WILL BE RQUIRED FOR THE NON-STANDAR DRIVEWAY, LANDSCAPING, CRUSHED

ROCK, AND PAVERS WITHIN THE HILLSIDE DRIVE RIGHT-OF-WAY. 07. THIS PROJECT WILL NOT DISCHARGE ANY INCREASE IN STORM WATER RUN-OFF ONTO THE

EXISTING HILLSIDE AREA. 08. AT THE STORM WATER DISCHARGE LOCATION, SUITABLE ENERGY DISSIPATERS ARE TO BE

INSTALLED TO REDUCE THE DISCHARGE TO NON-ERODIBLE VELOCITIES.

09. NO ADDITIONAL RUN-OFF IS PROPOSED FOR THE DISCHARGE LOCATION.

**10**. NO OBSTRUCTION INCLUDING SOLID WALLS IN THE VISIBILITY AREA SHALL ESCEED 3 FEET IN HEIGHT. PLANT MATERIAL, OTHER THAN TREES, WITHIN THE PUBLIC RIGHT-OF-WAY THAT IS LOCATED WITH VISIBILITY AREAS SHALL NOT EXCEED 24 INCHES IN HEIGHT, MEASURED FROM THE TOP OF


THE ADJACENT CURB. 11. PRIOR TO THE ISSUANCE OF ANY CONSTRUCTION PERMIT, THE OWNER/PERMITTEE SHALL ENTER INTO A MAINTANCE AGREEMENT FOR ONGOING PERMANENT BMP MAINTENANCE, SATISFACTORY TO THE CITY ENGINEER.

12. PRIOR TO THE ISSUANCE OF ANY CONSTRUCTION PERMIT, THE OWNER/PERMITTEE SHALL INCORPORATE ANY CONSTRUCTION BEST MANAGEMENT PRACTICES NECESSARY TO COMPLY WITH CHAPTER 14, ARTICLE 2, DIVICION 1 (GRADING REGULATION) OF THE SAN DIEGO MUNICIPAL CODE, INTO THE CONSTRUCTION PLANS OR SPECIFICATION. 13. PRIOR TO THE ISSUANCE OF ANY CONSTRUCTION PERMIT, THE OWNER/PERMITTEE SHALL SUBMIT A WATER POLLUTION CONTROL PLAN. THE WPCP SHALL BE PREPARED IN ACCORDANCE WITH THE GUIDELINES IN PART 2 CONSTRUCTION BMP STANDARS CHAPTER 4 OF THE CITY'S STORM WATER

STANDARS. **14**. ALL NEW RUNOFF TO BE DIRECTED AWAY FROM THE STEEP HILLSIDE AND INTO A PUBLIC STORM DRAIN OR ONTO A STREET DEVELOPED WITH A GUTTER SYSTEM, SECTION 143.0142(f).

15. NO OBSTRUCTION INCLUDING SOLID WALLS IN THE VISIBILITY AREA SHALL EXCEED 3 FEET IN HEIGHT. PLANT MATERIAL, OTHER THAN TREES, WITHIN THE PUBLIC RIGHT-OF-WAY THAT IS LOCATED WITHIN VISIBILITY AREAS SHALL NOT EXCEED 24 INCHES IN HEIGHT, MEASURED FROM THE TOP OF THE ADJACENT CURB.



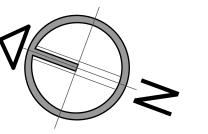

NORTH 2nd review - 5.19.2020 3rd review - 5.28.2020 4th review - 10.14.2020


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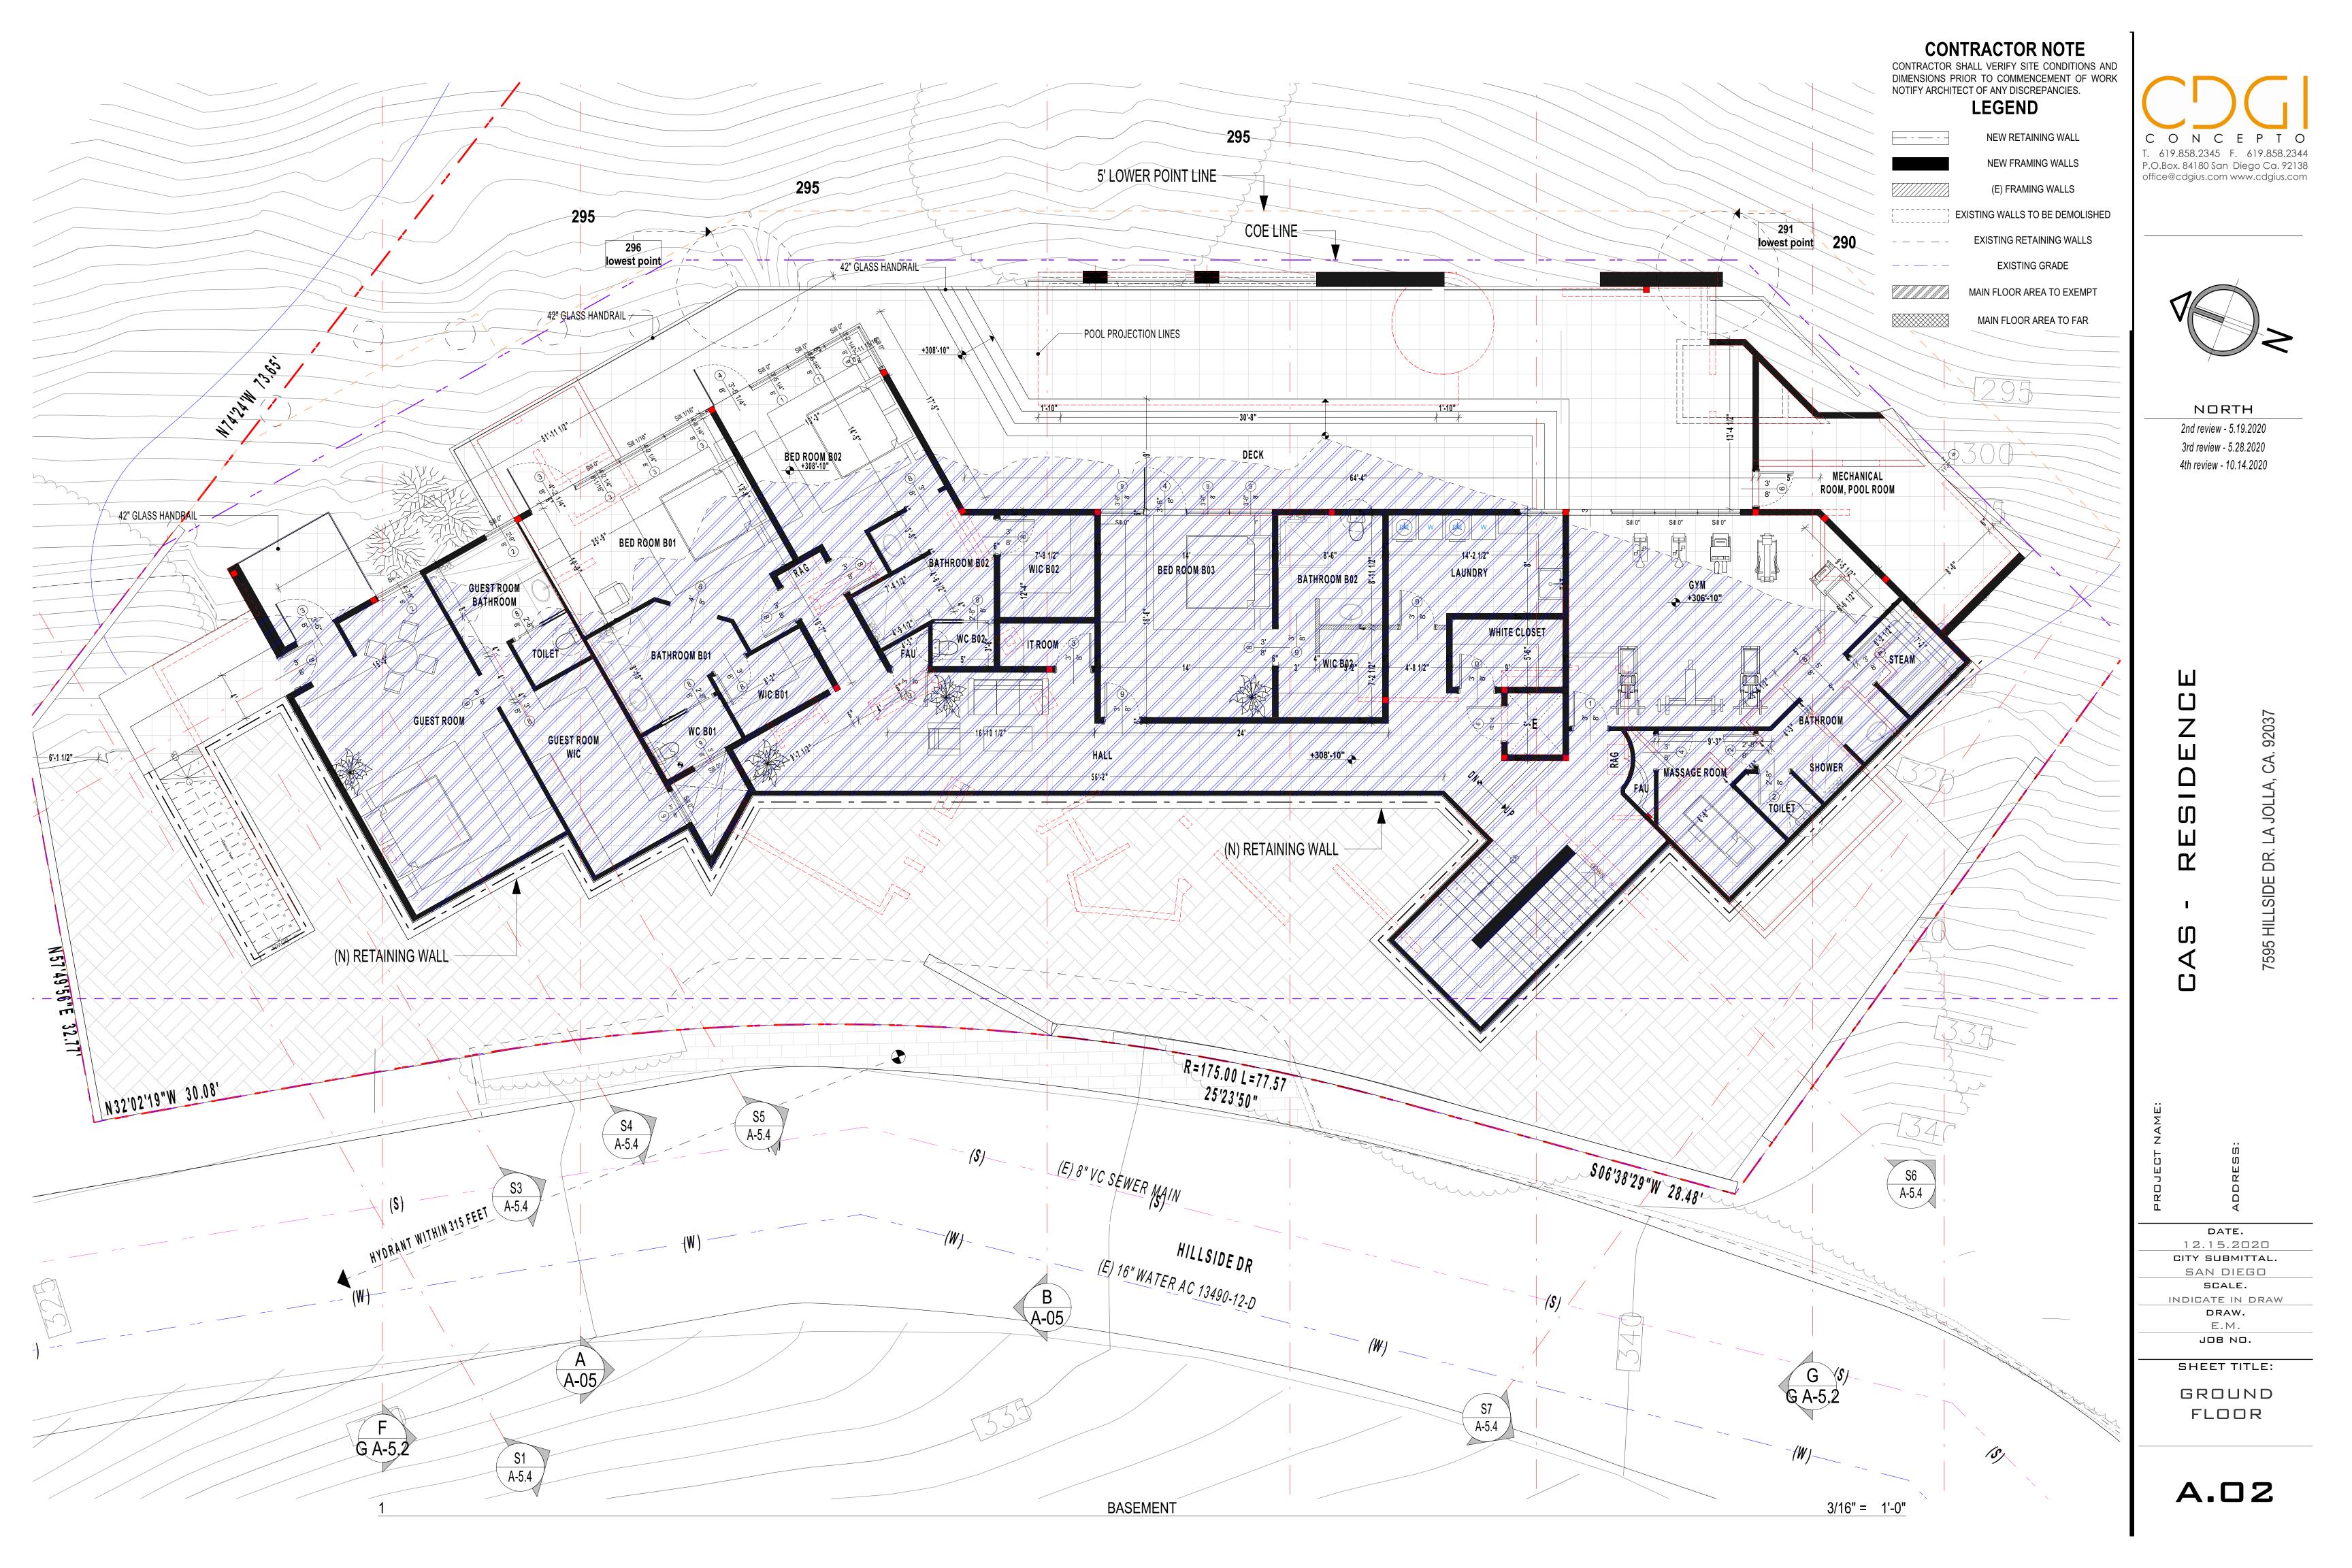
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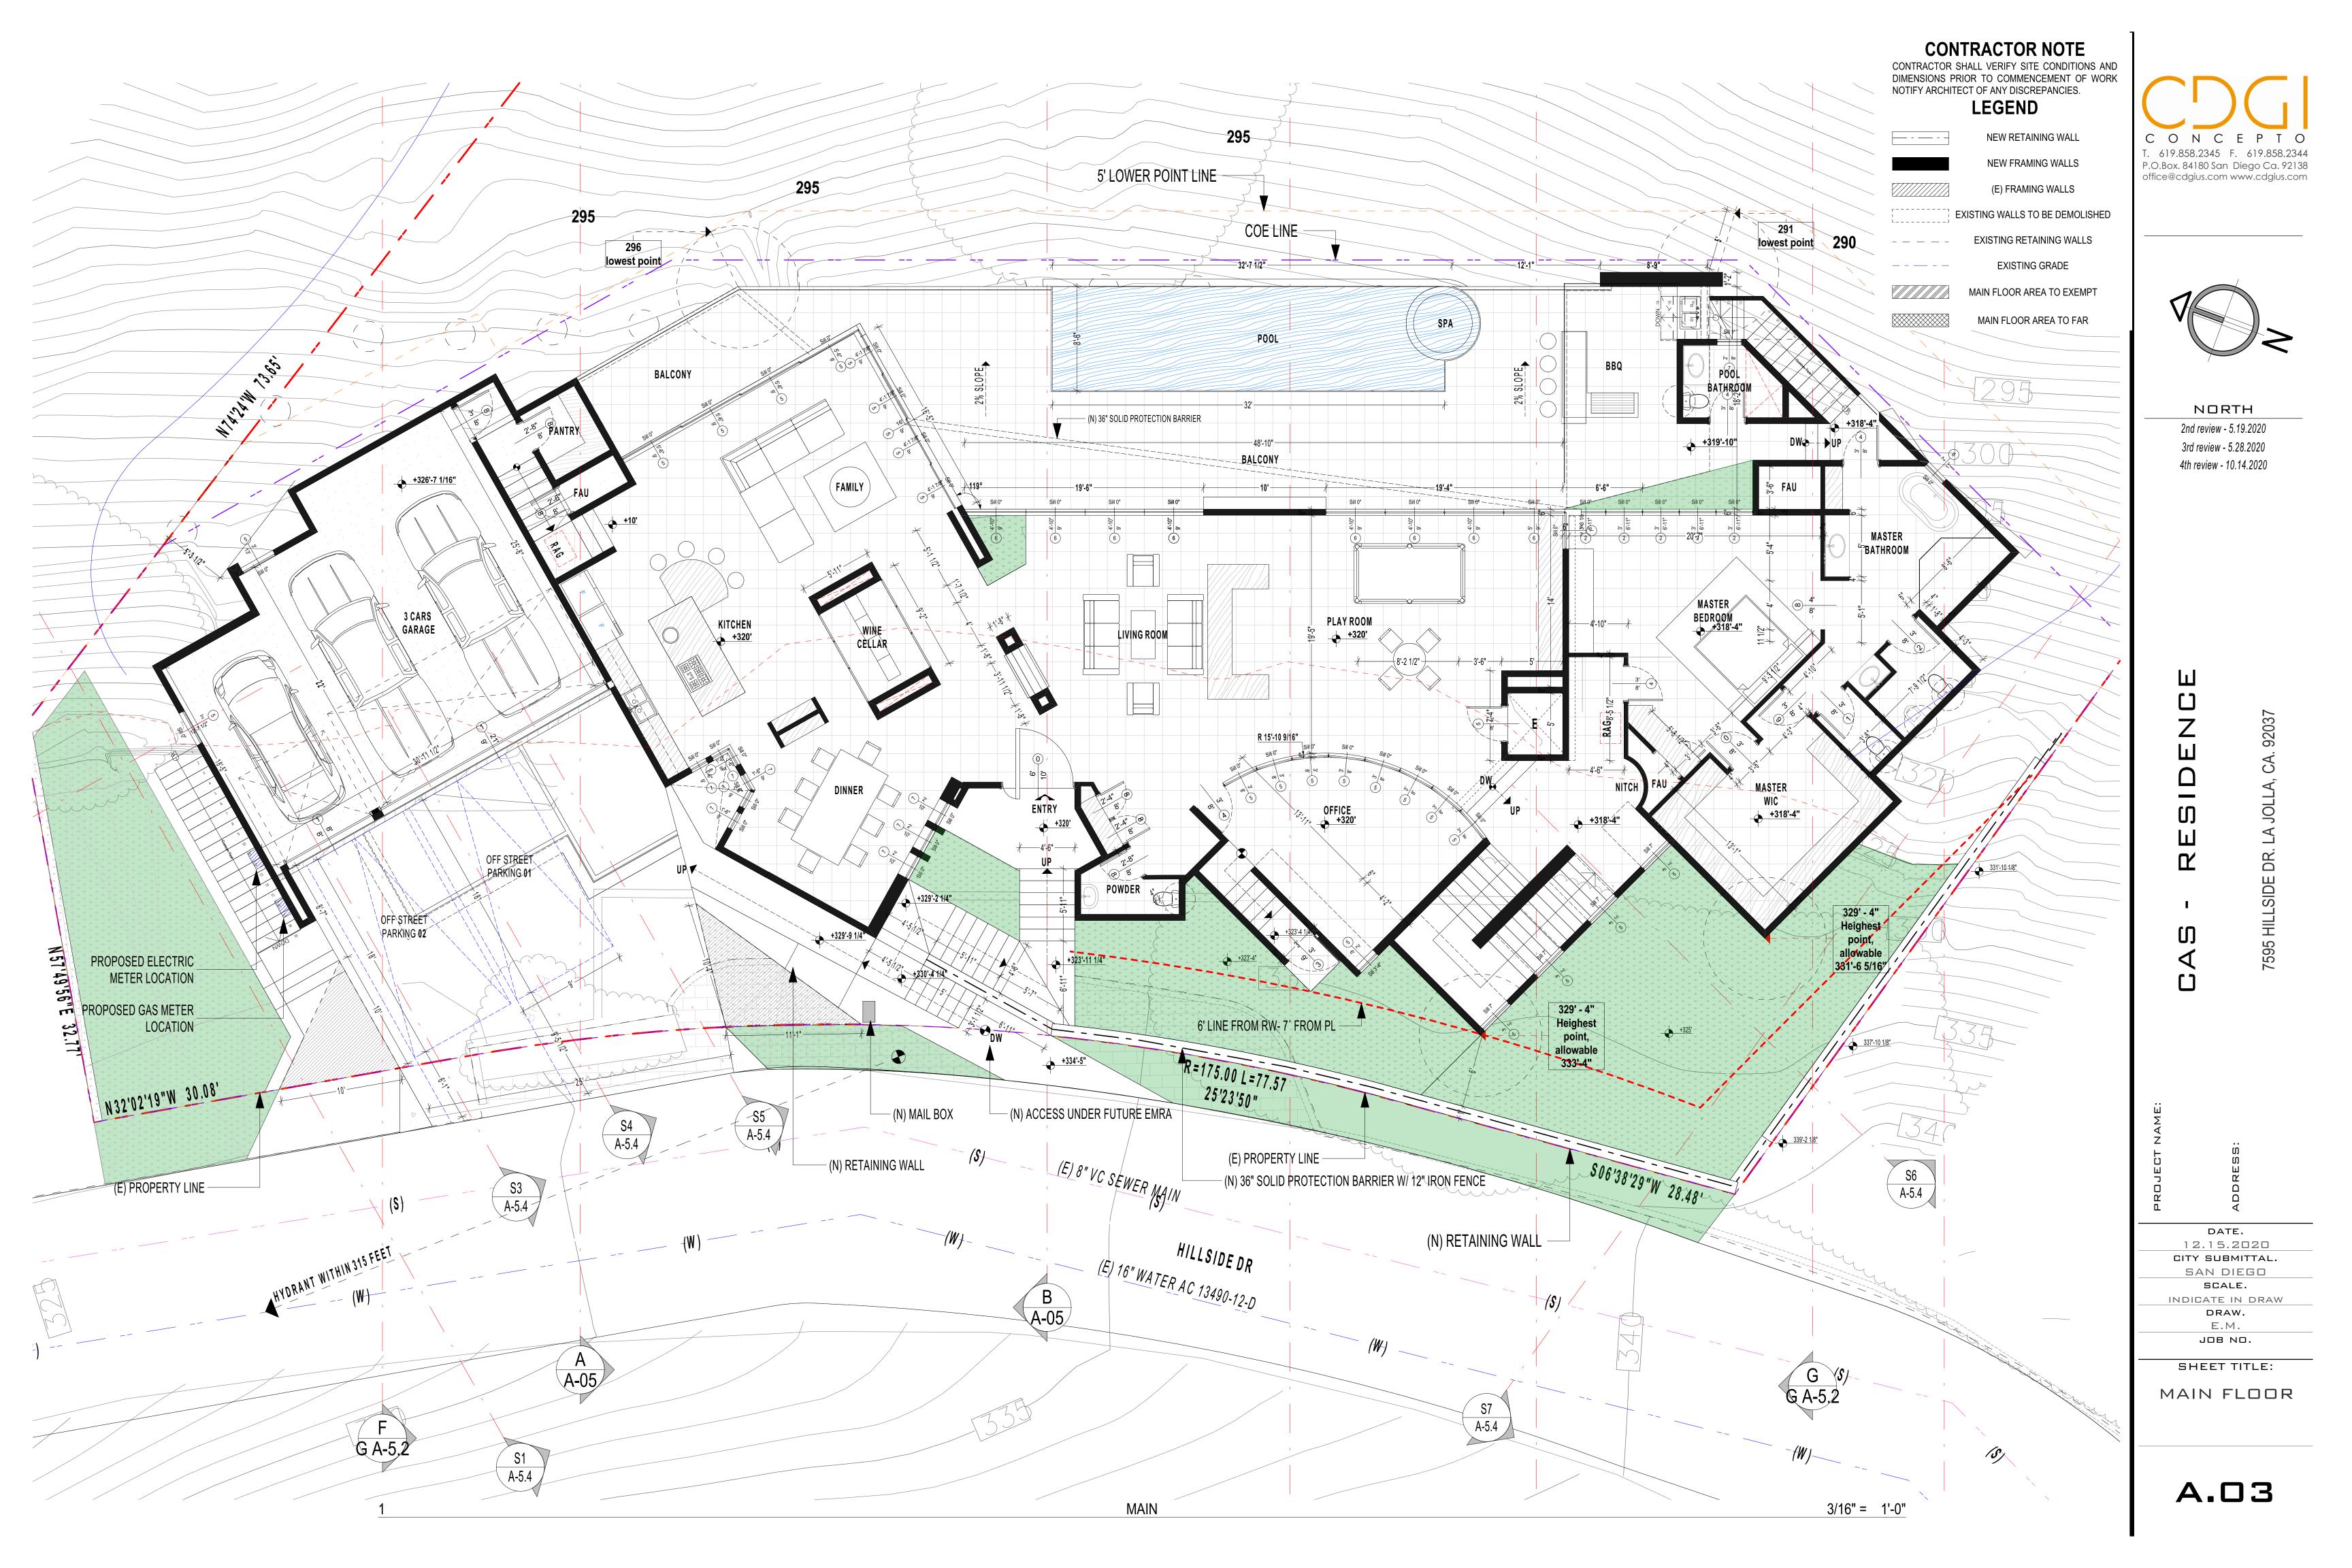
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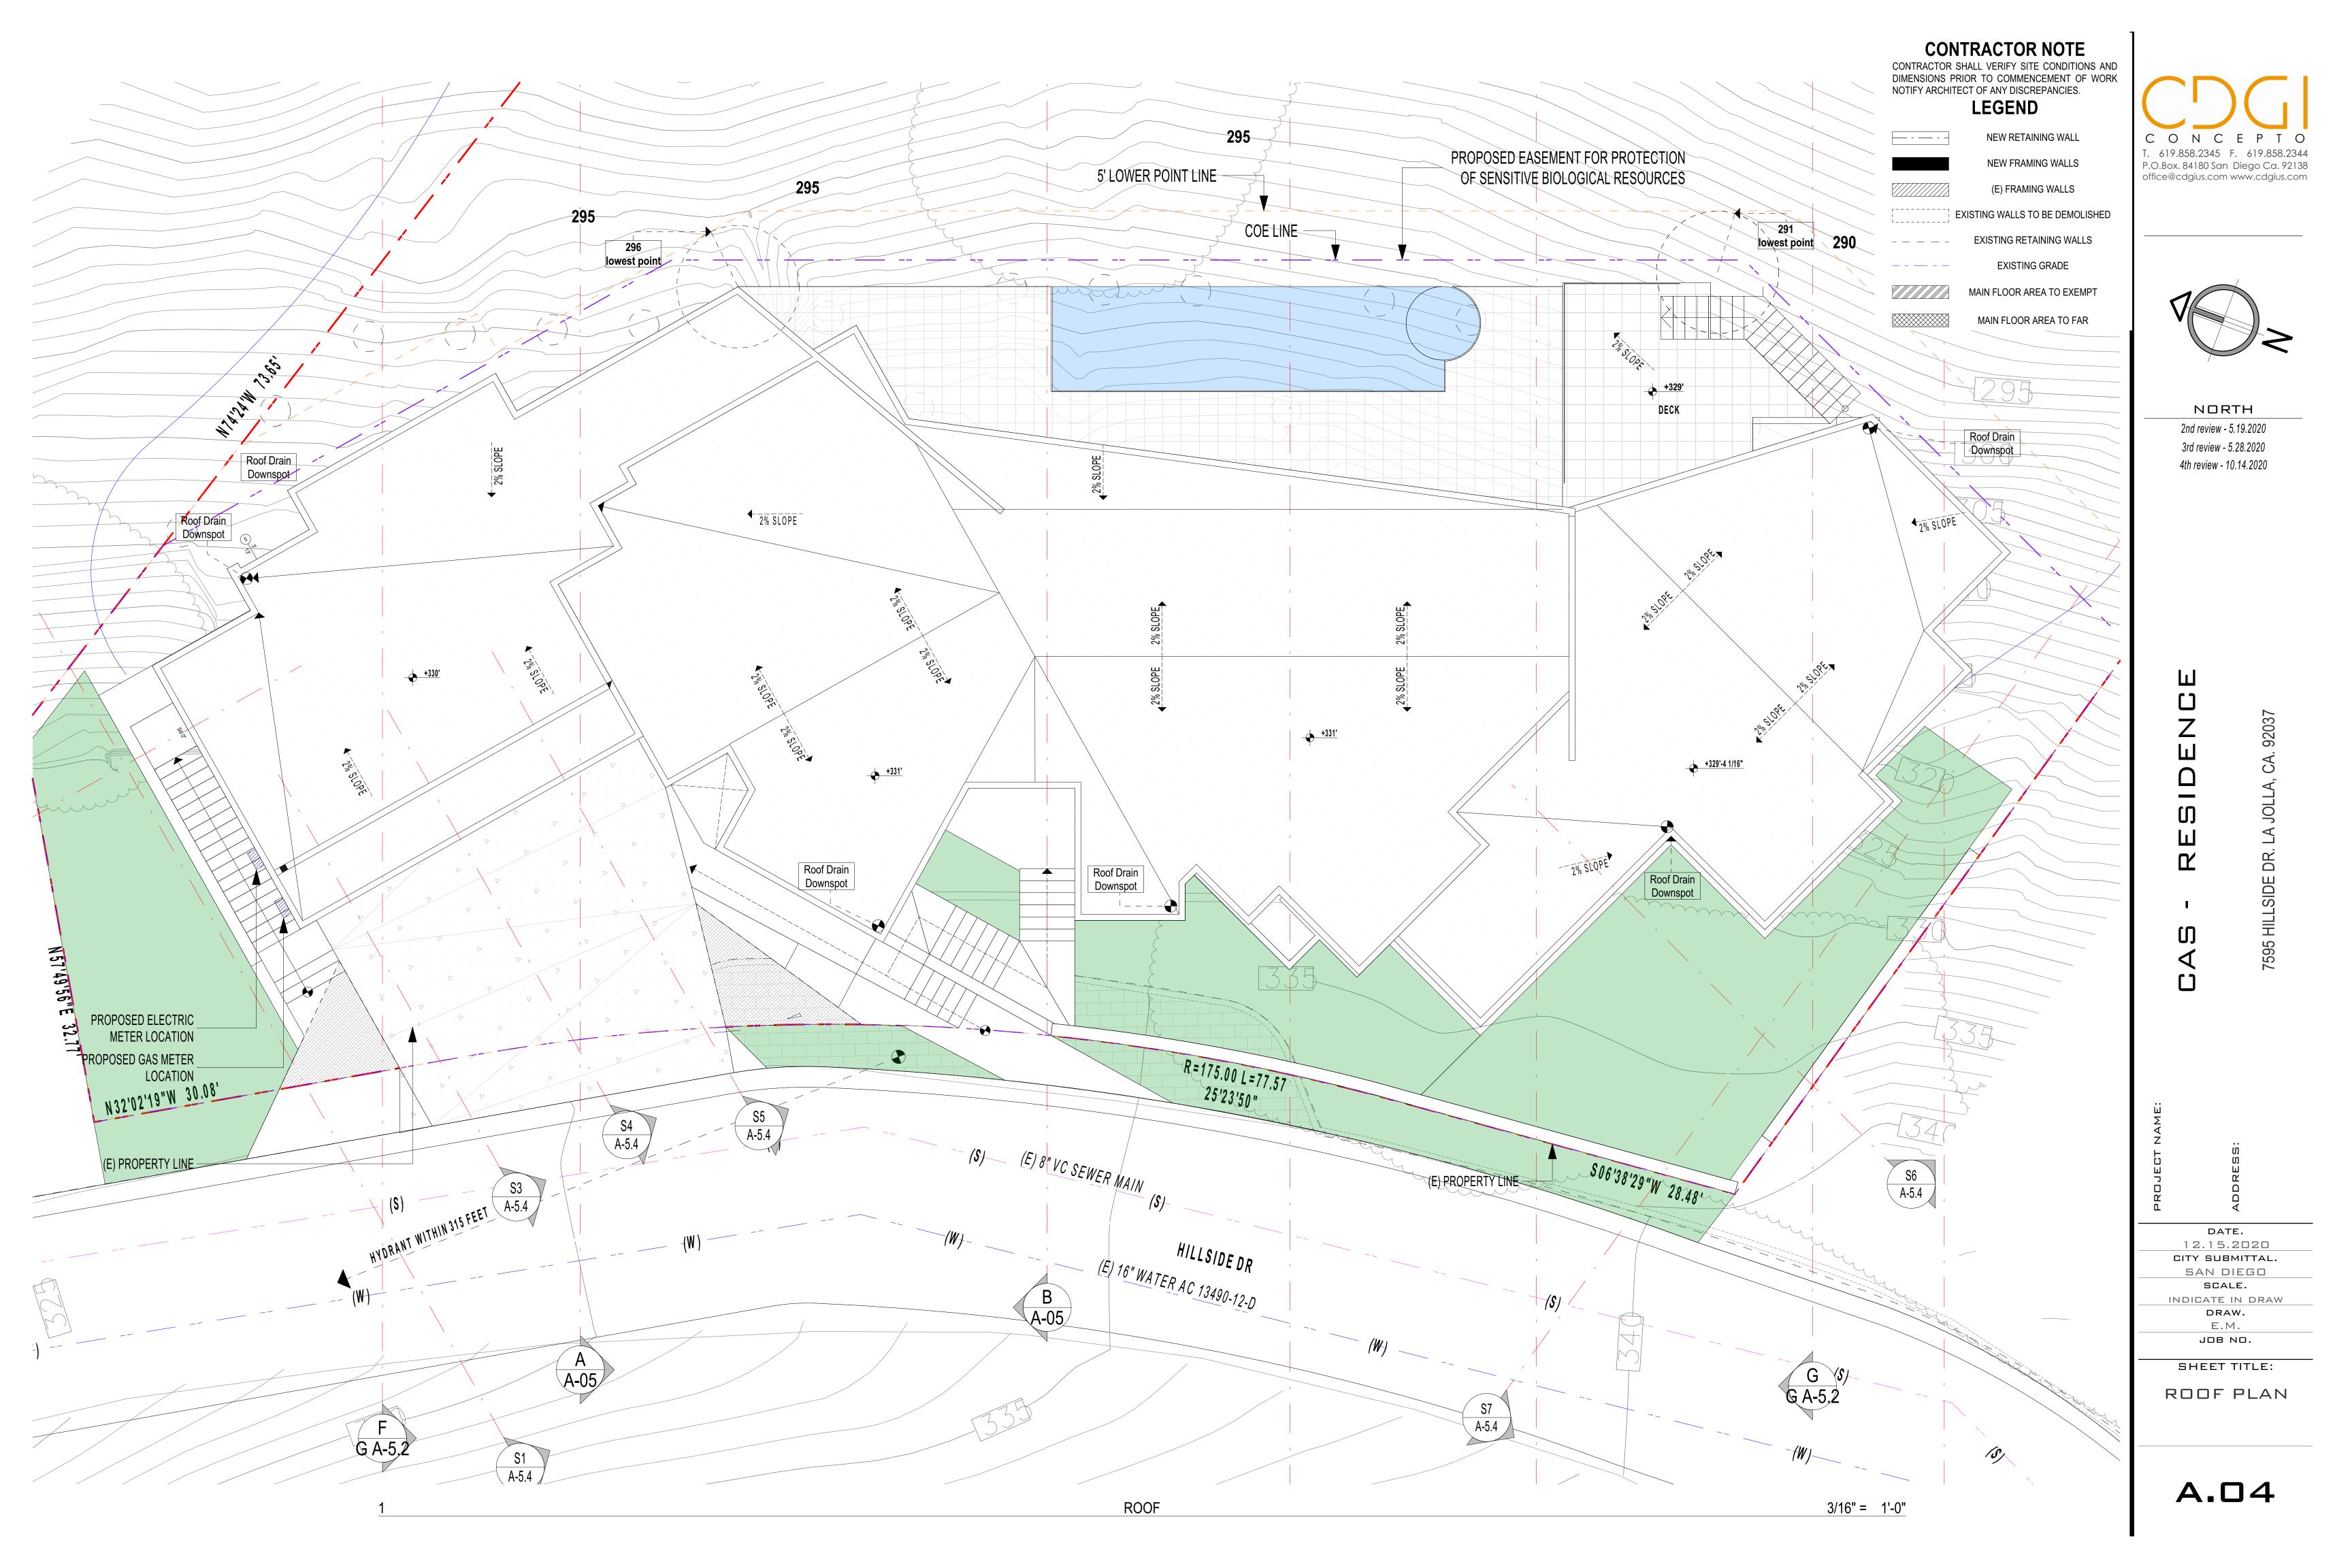
SITE PLAN


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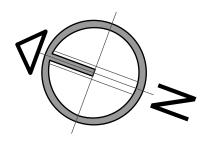








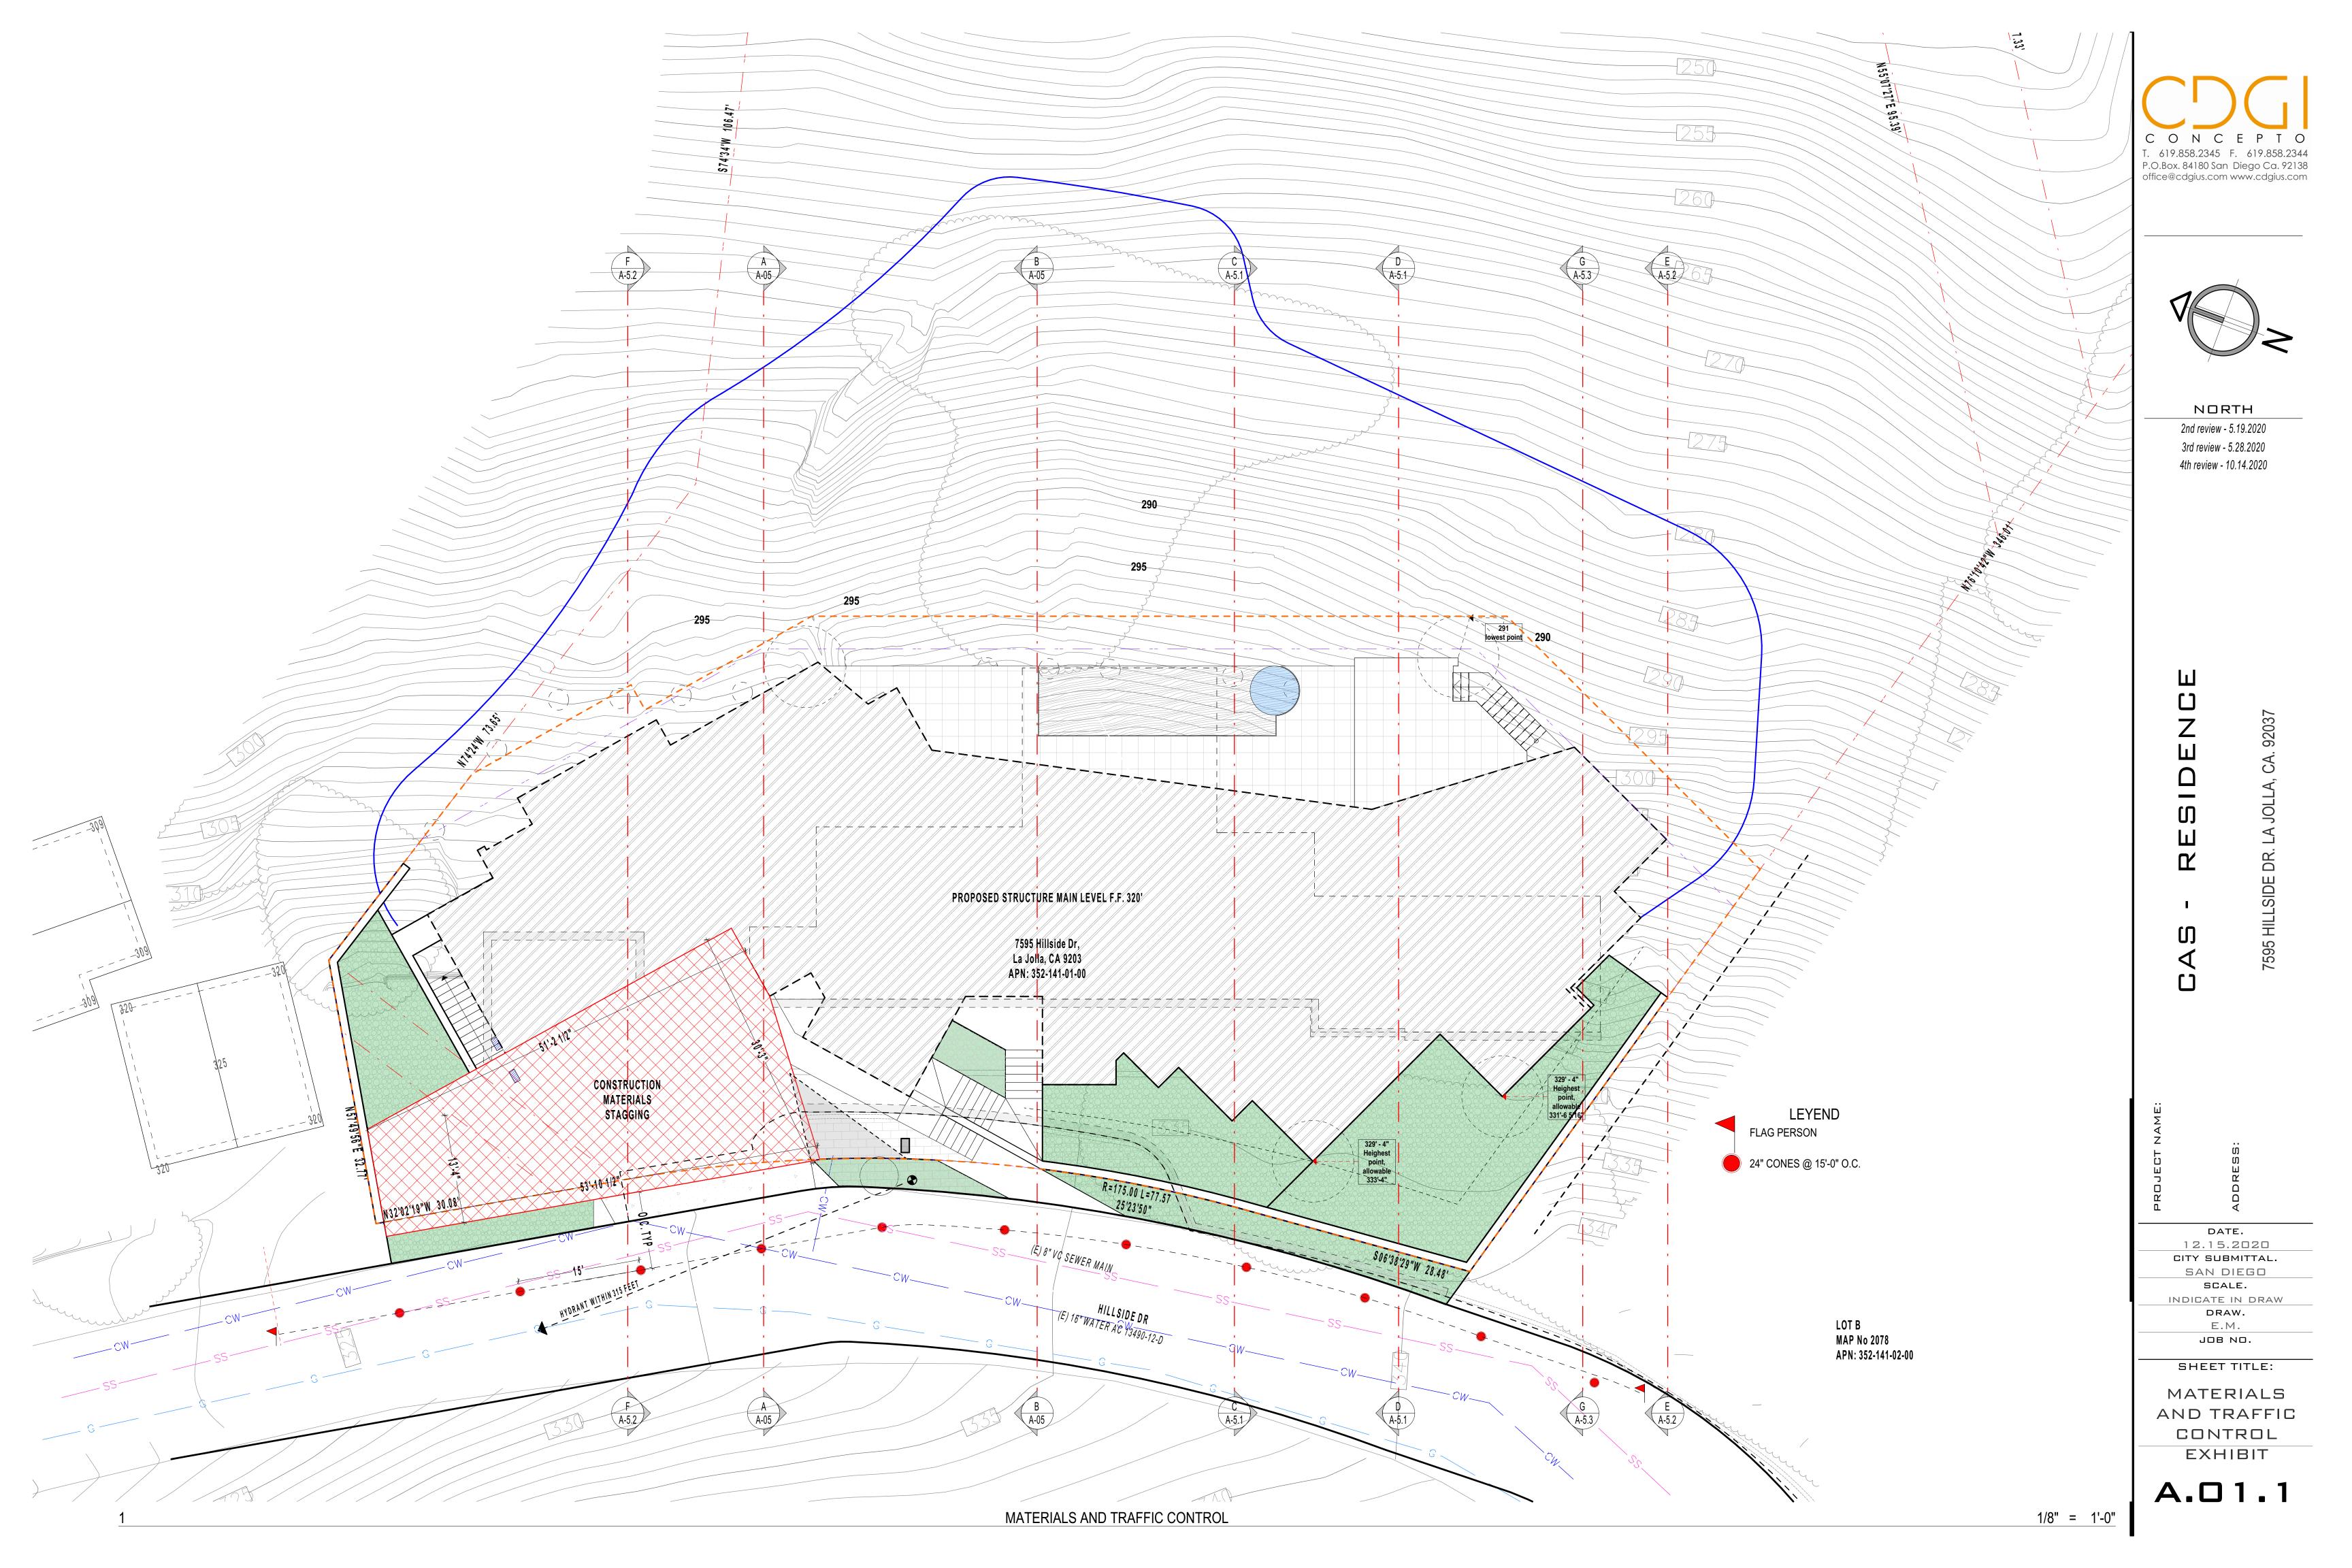

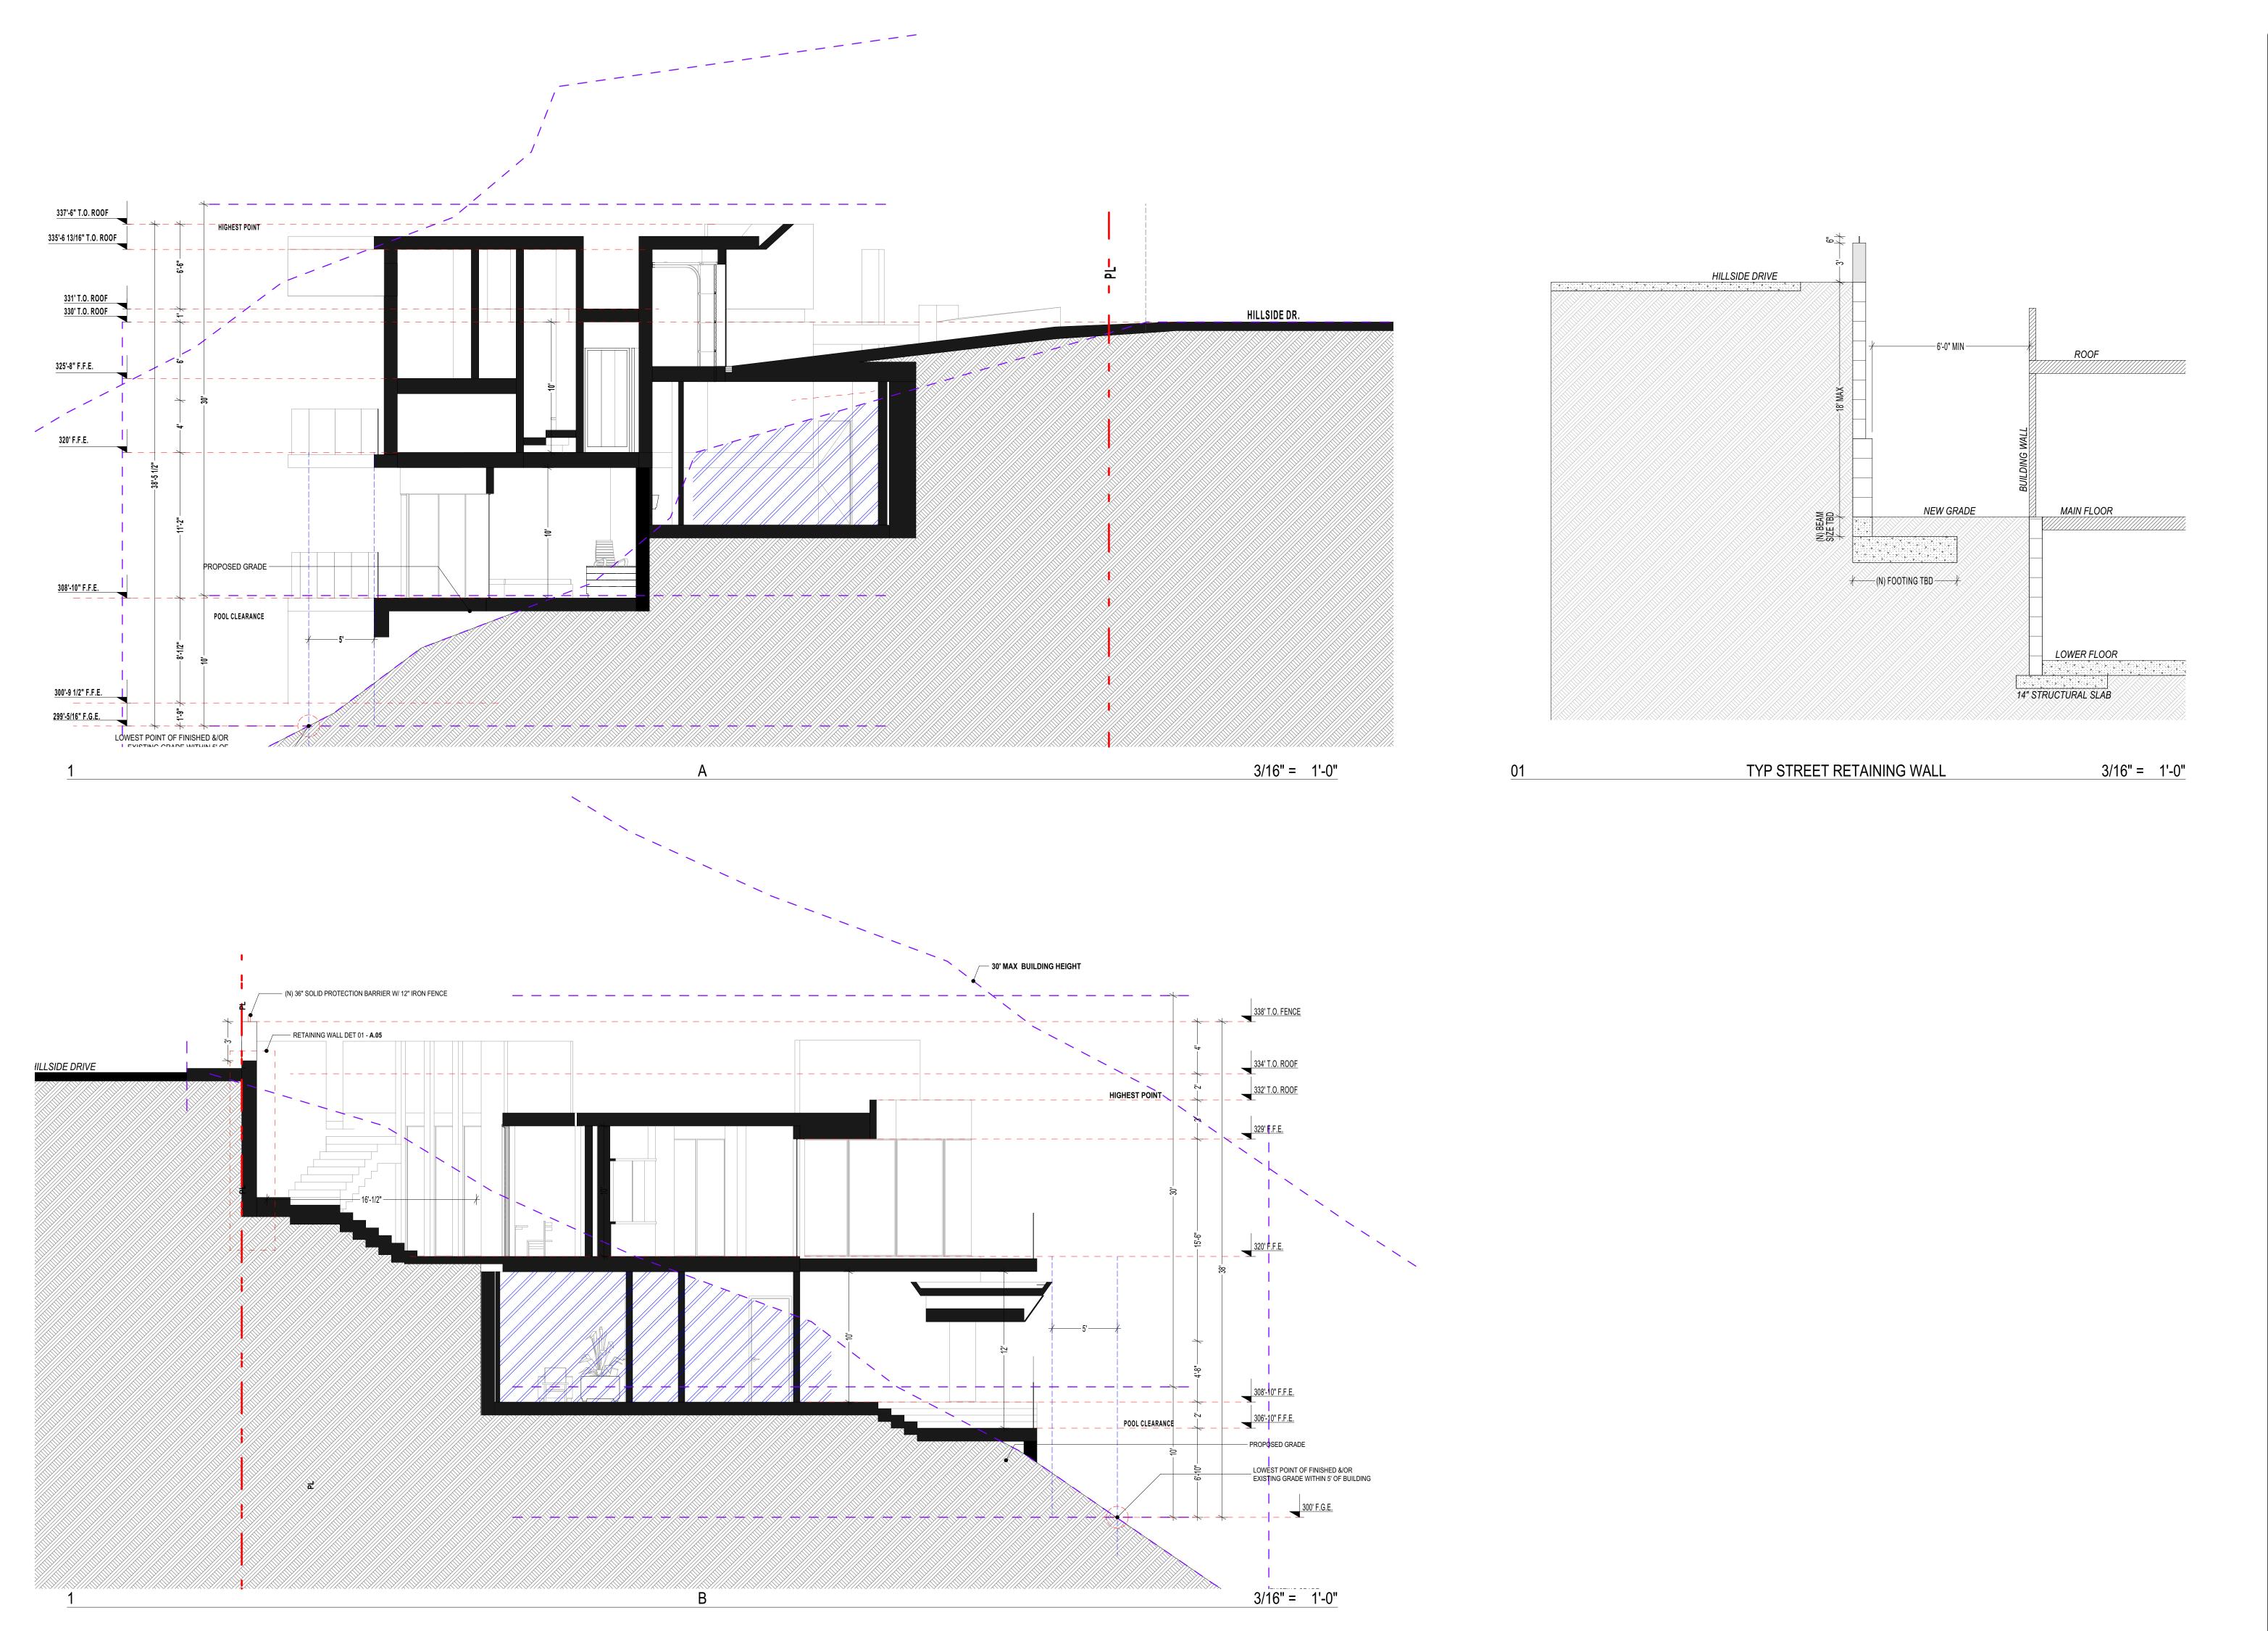

3rd review - 5.28.2020 4th review - 10.14.2020

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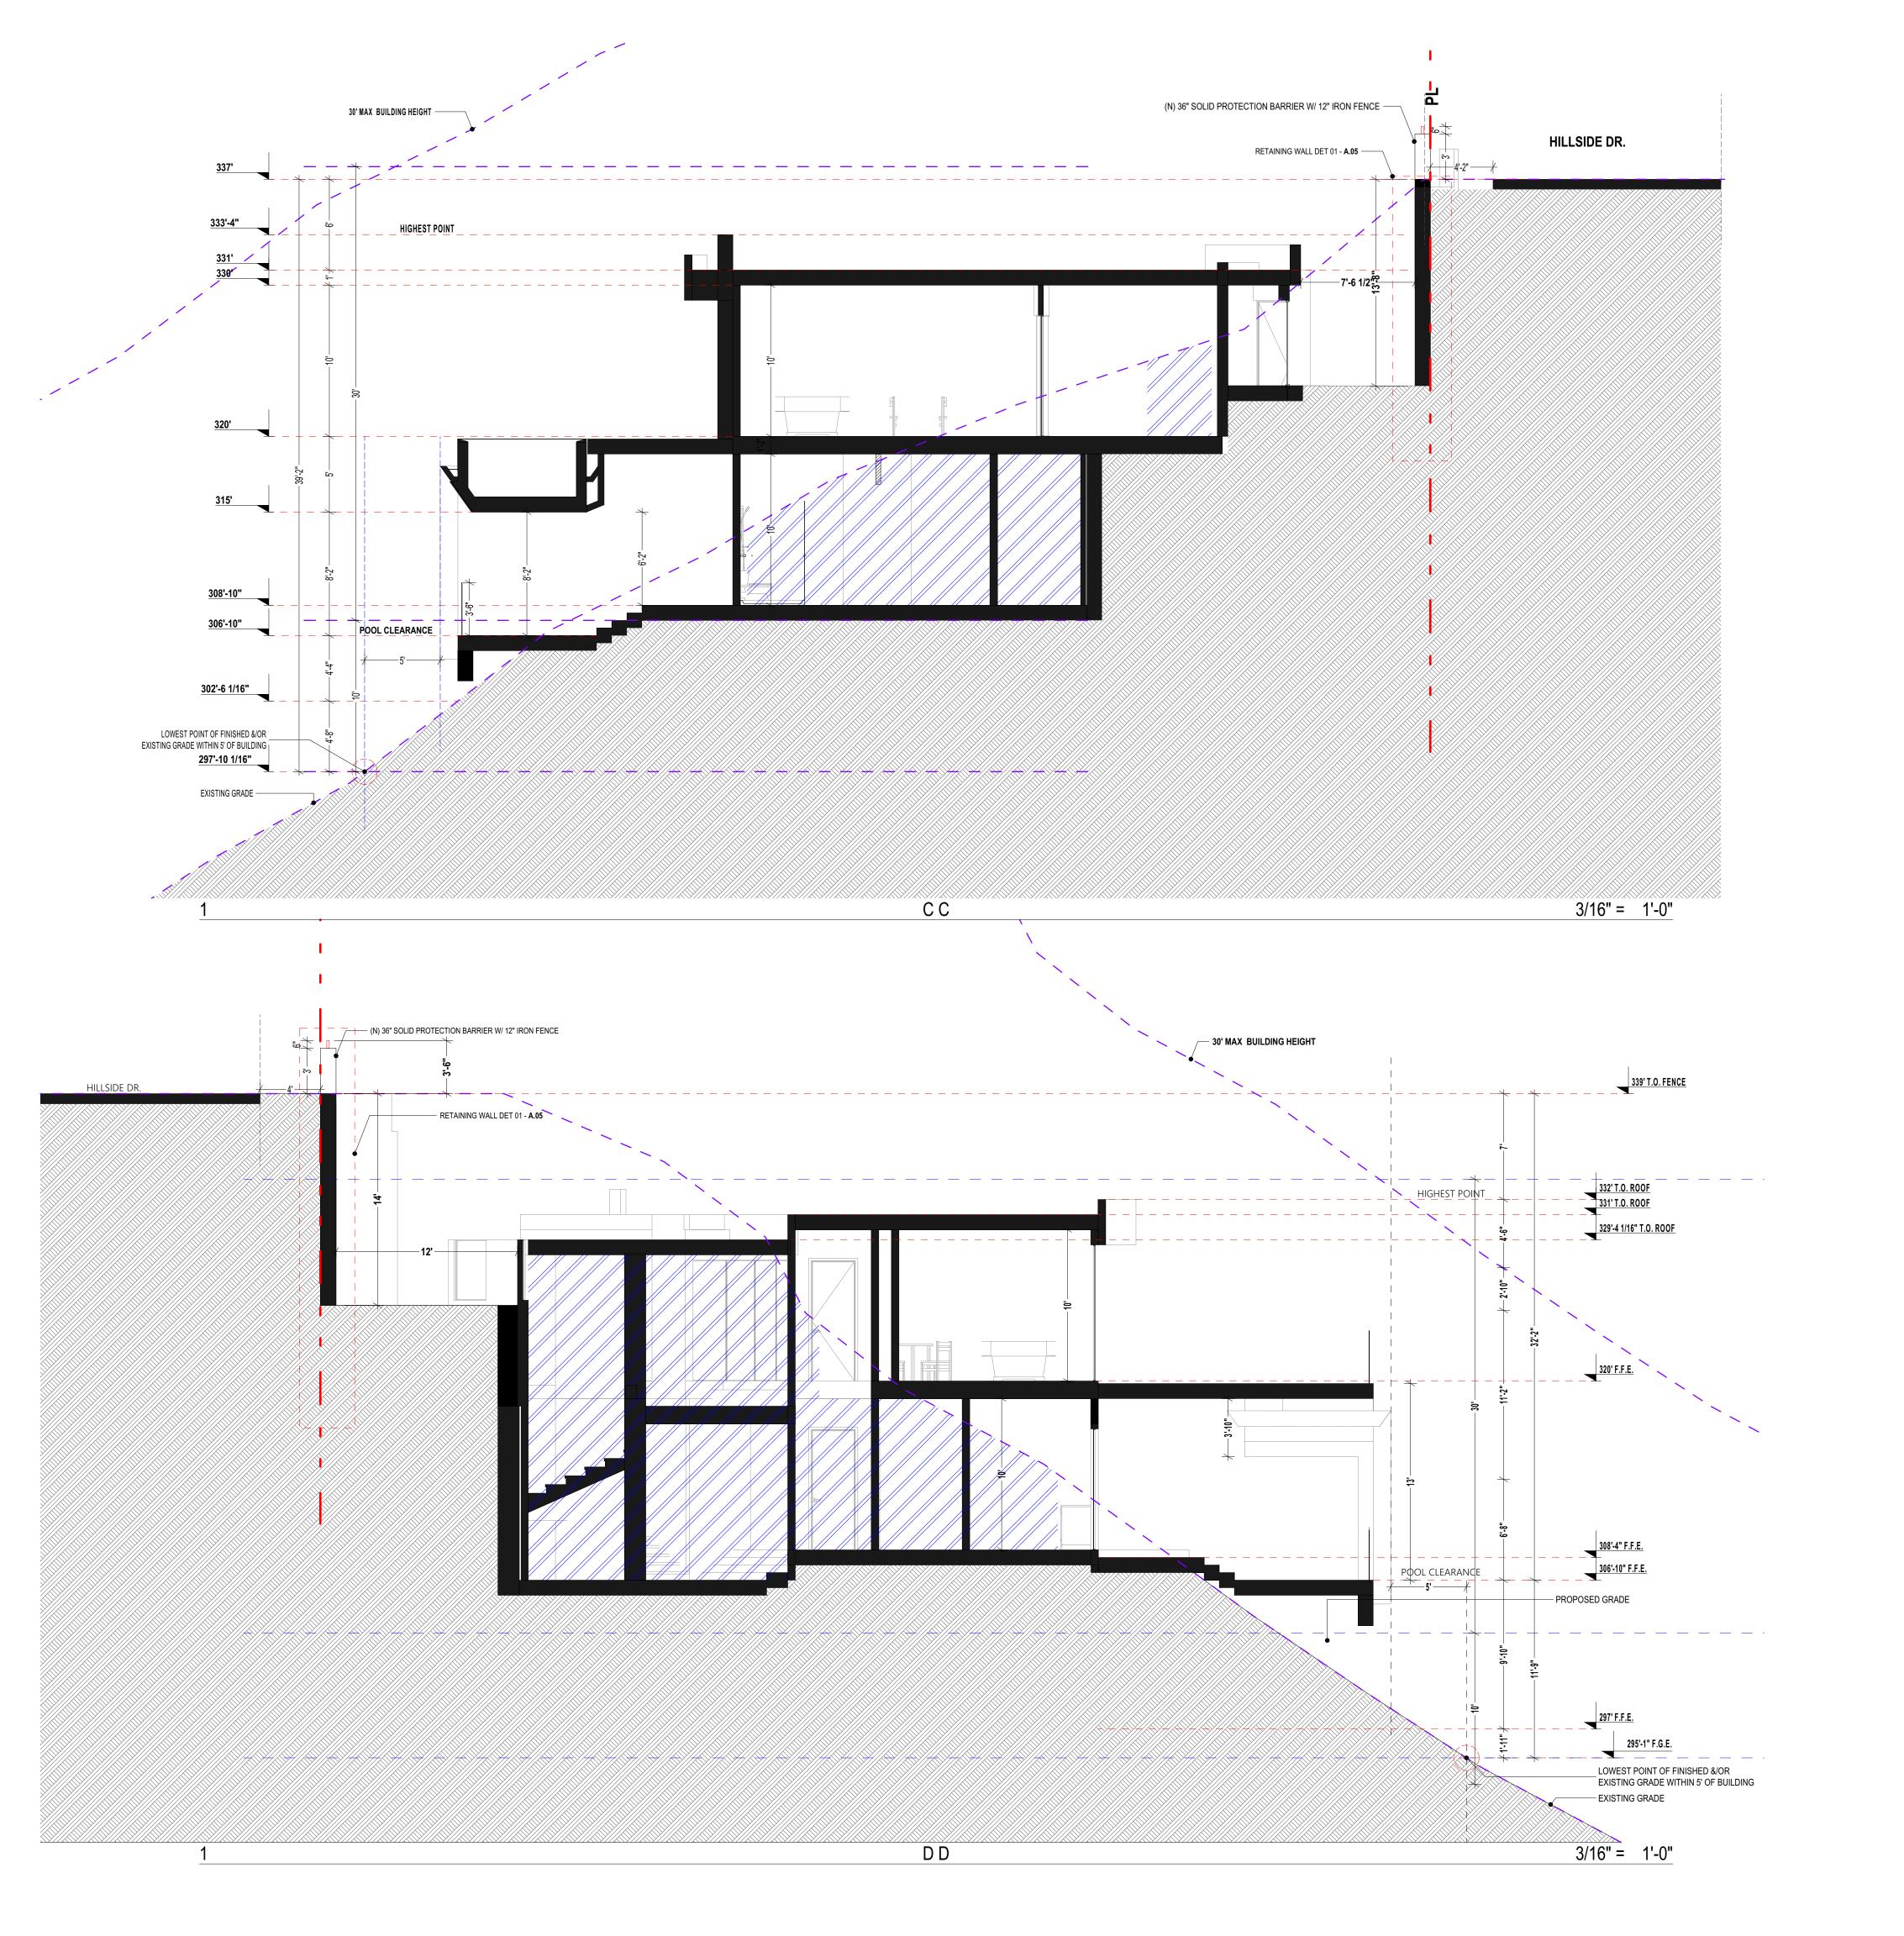
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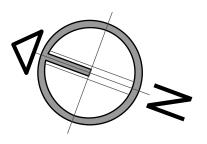
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SECTIONS A-B

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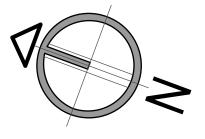
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2nd review - 5.19.2020 3rd review - 5.28.2020 4th review - 10.14.2020

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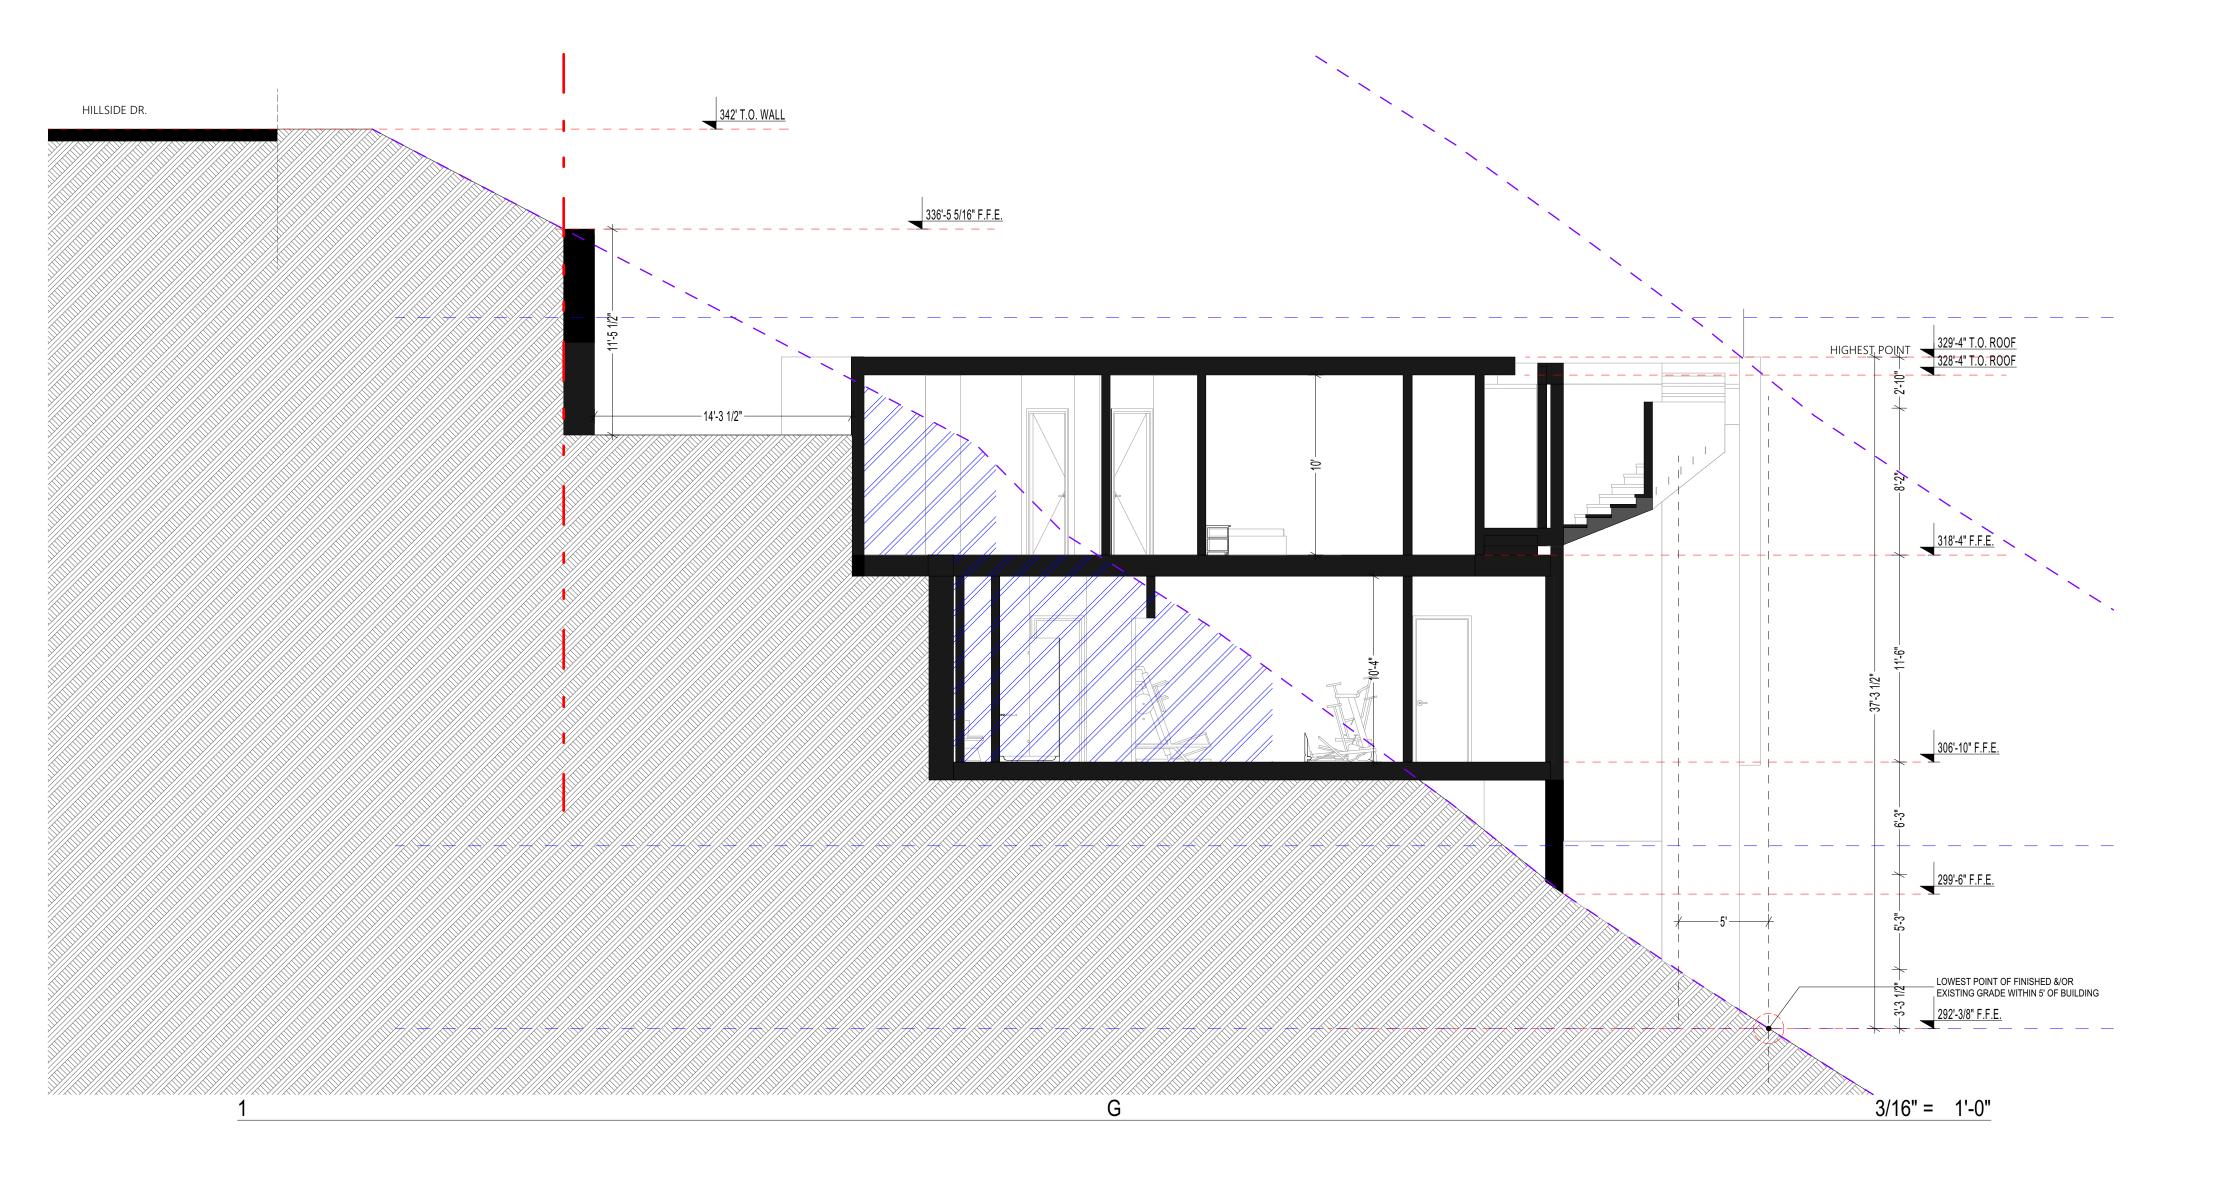
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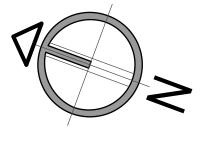
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SECTIONS E-F







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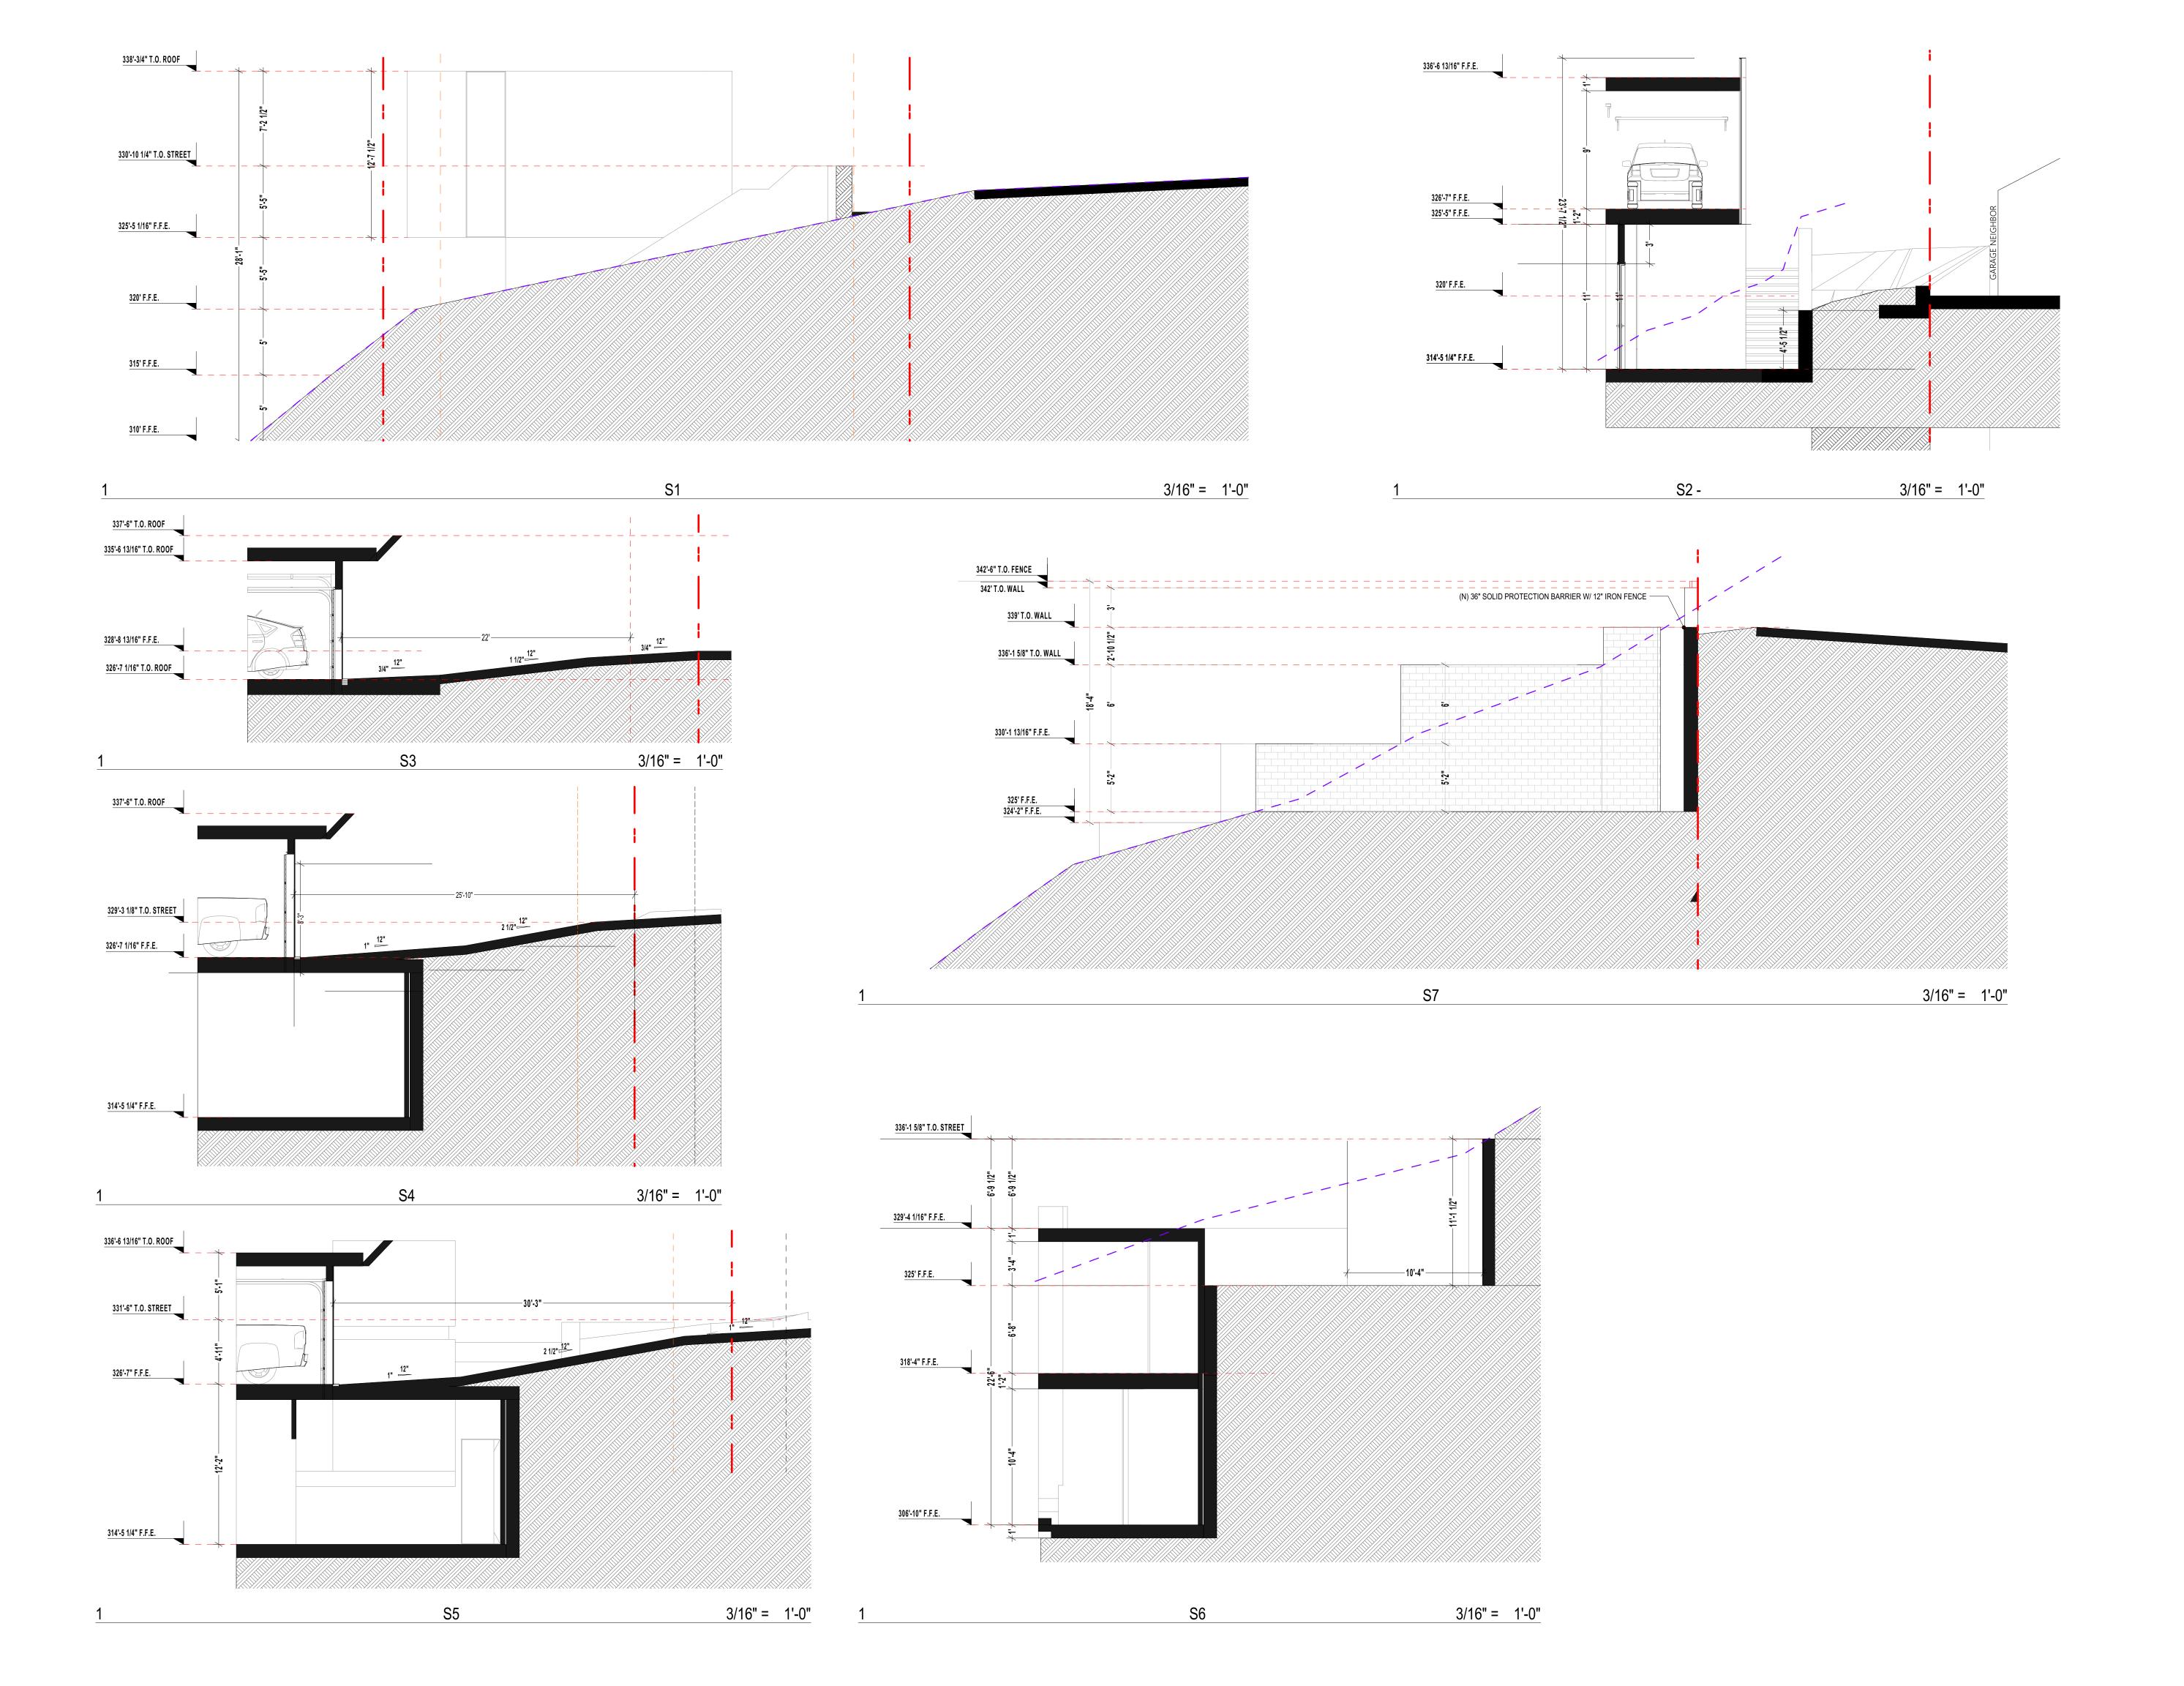
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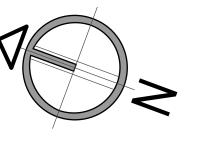
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SECTIONS G








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SHEET TITLE:
SECTIONS S1

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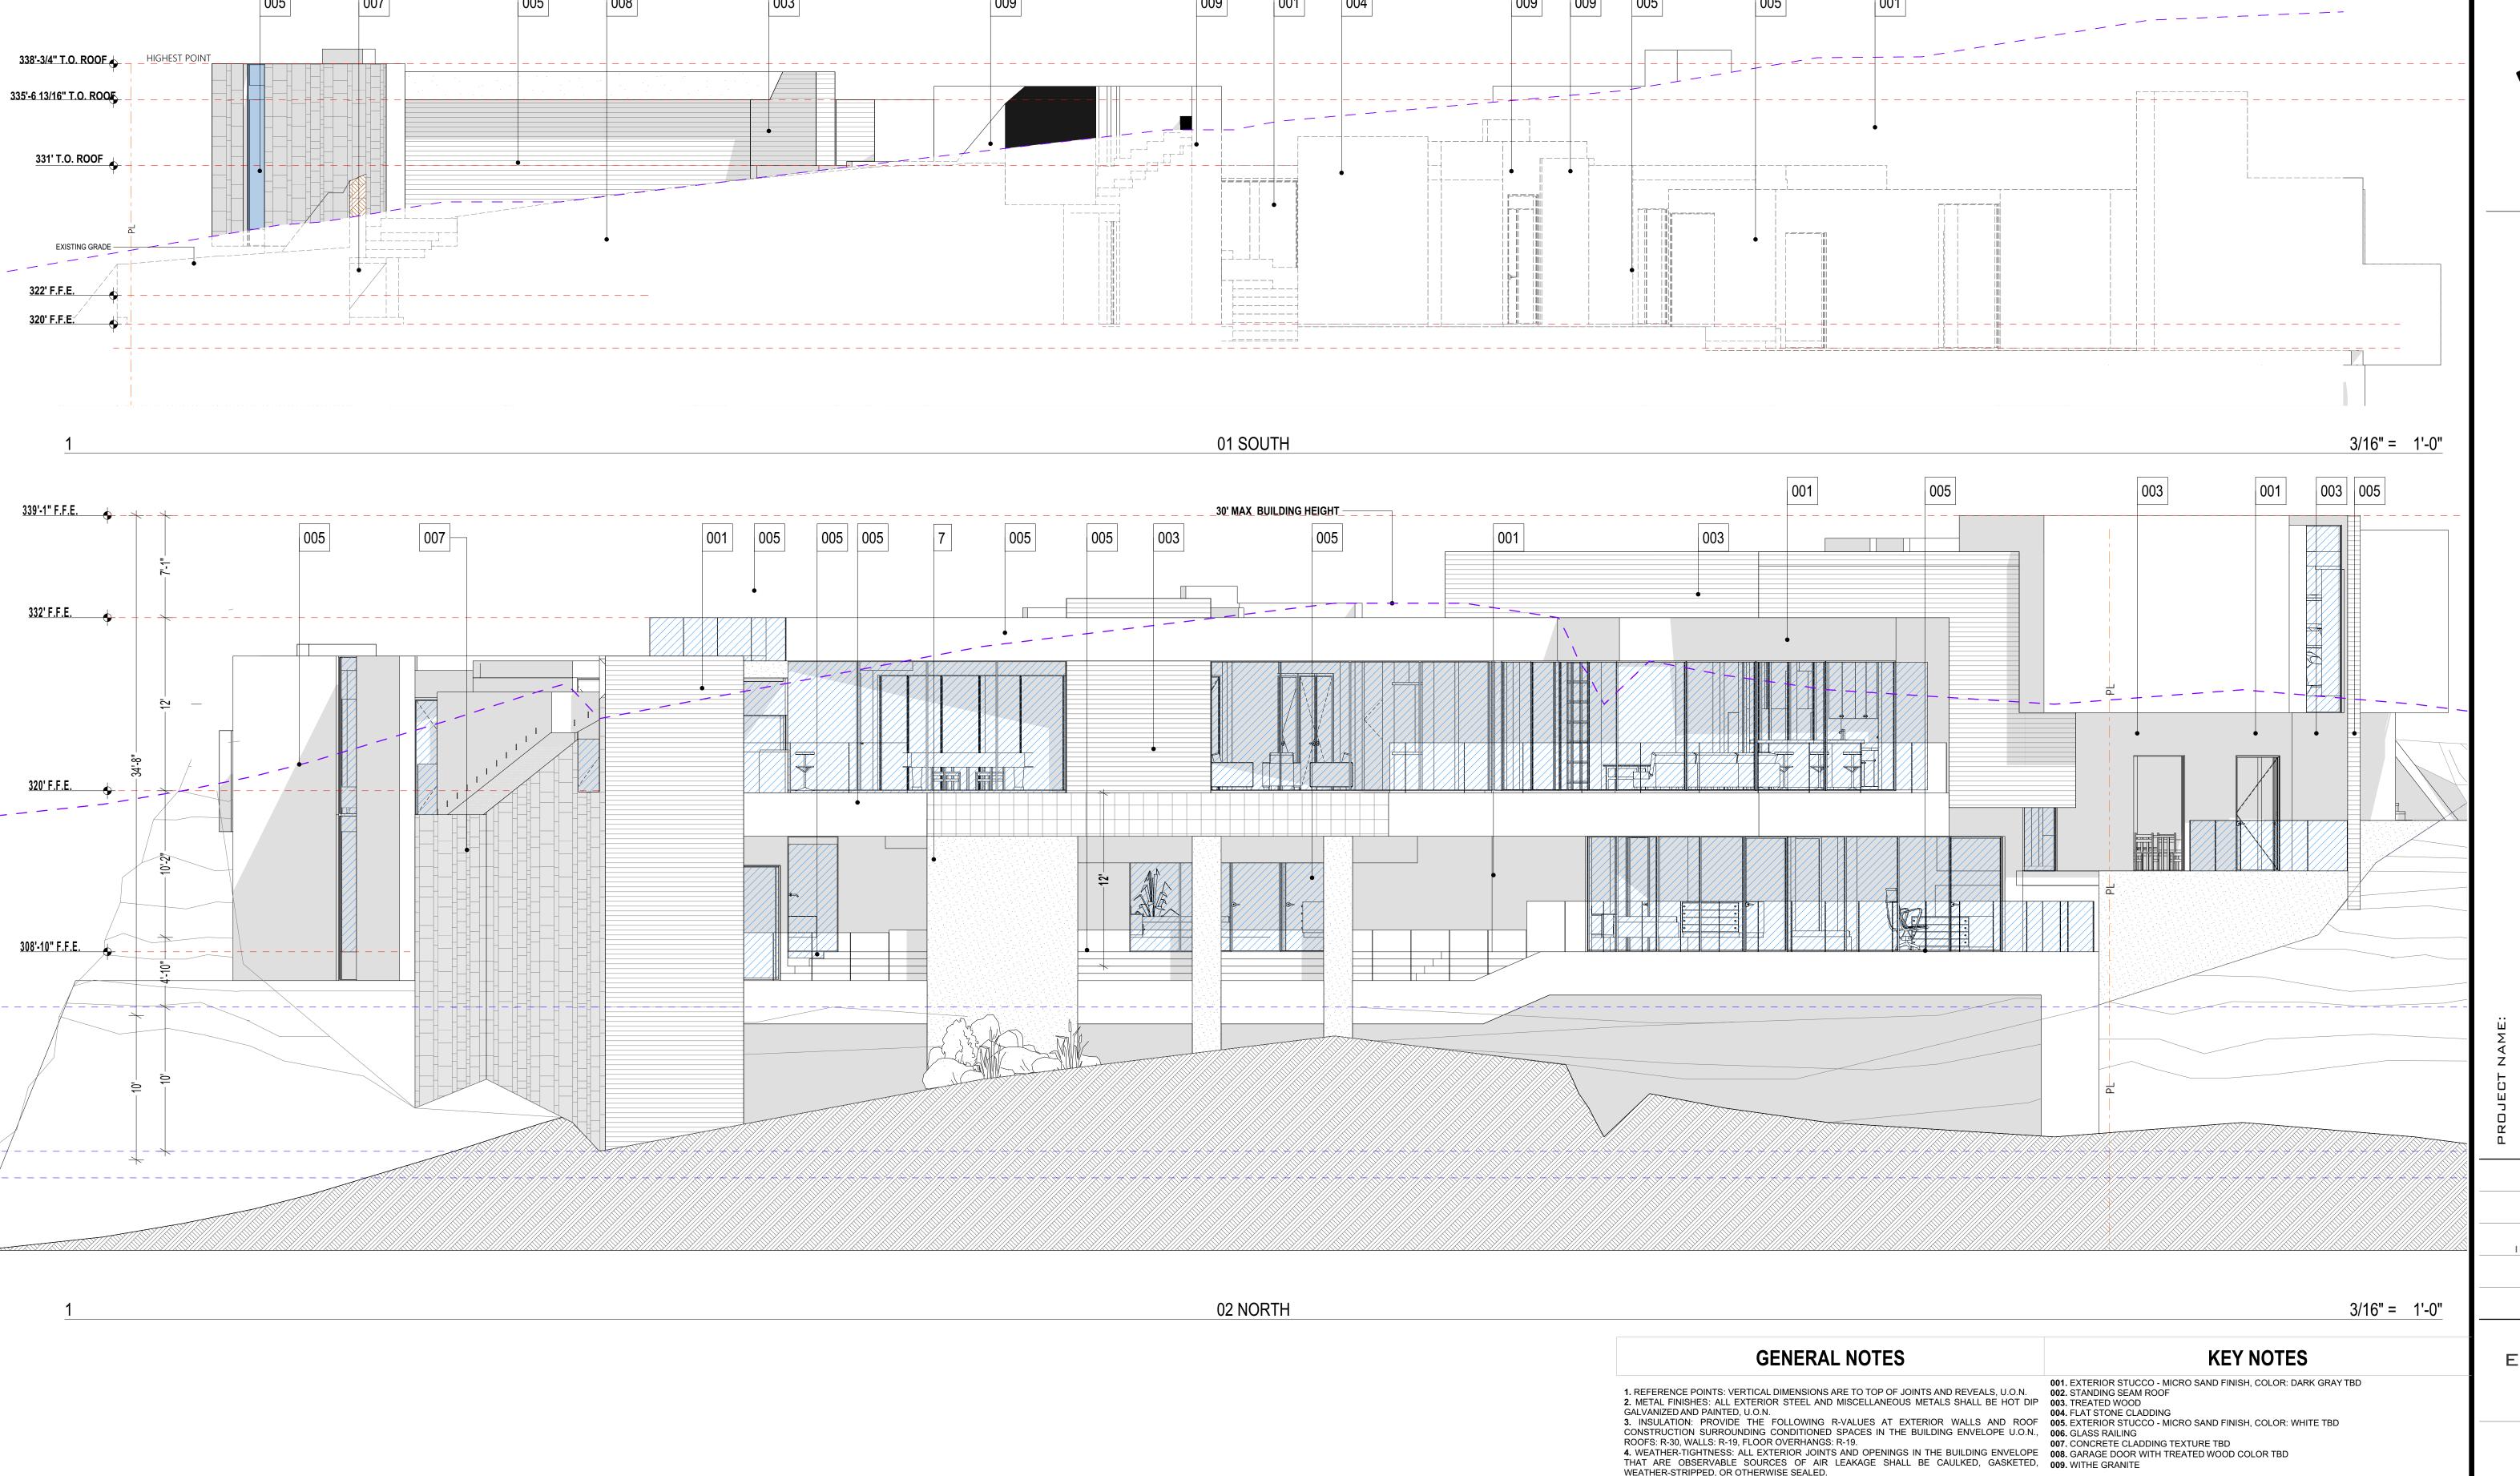
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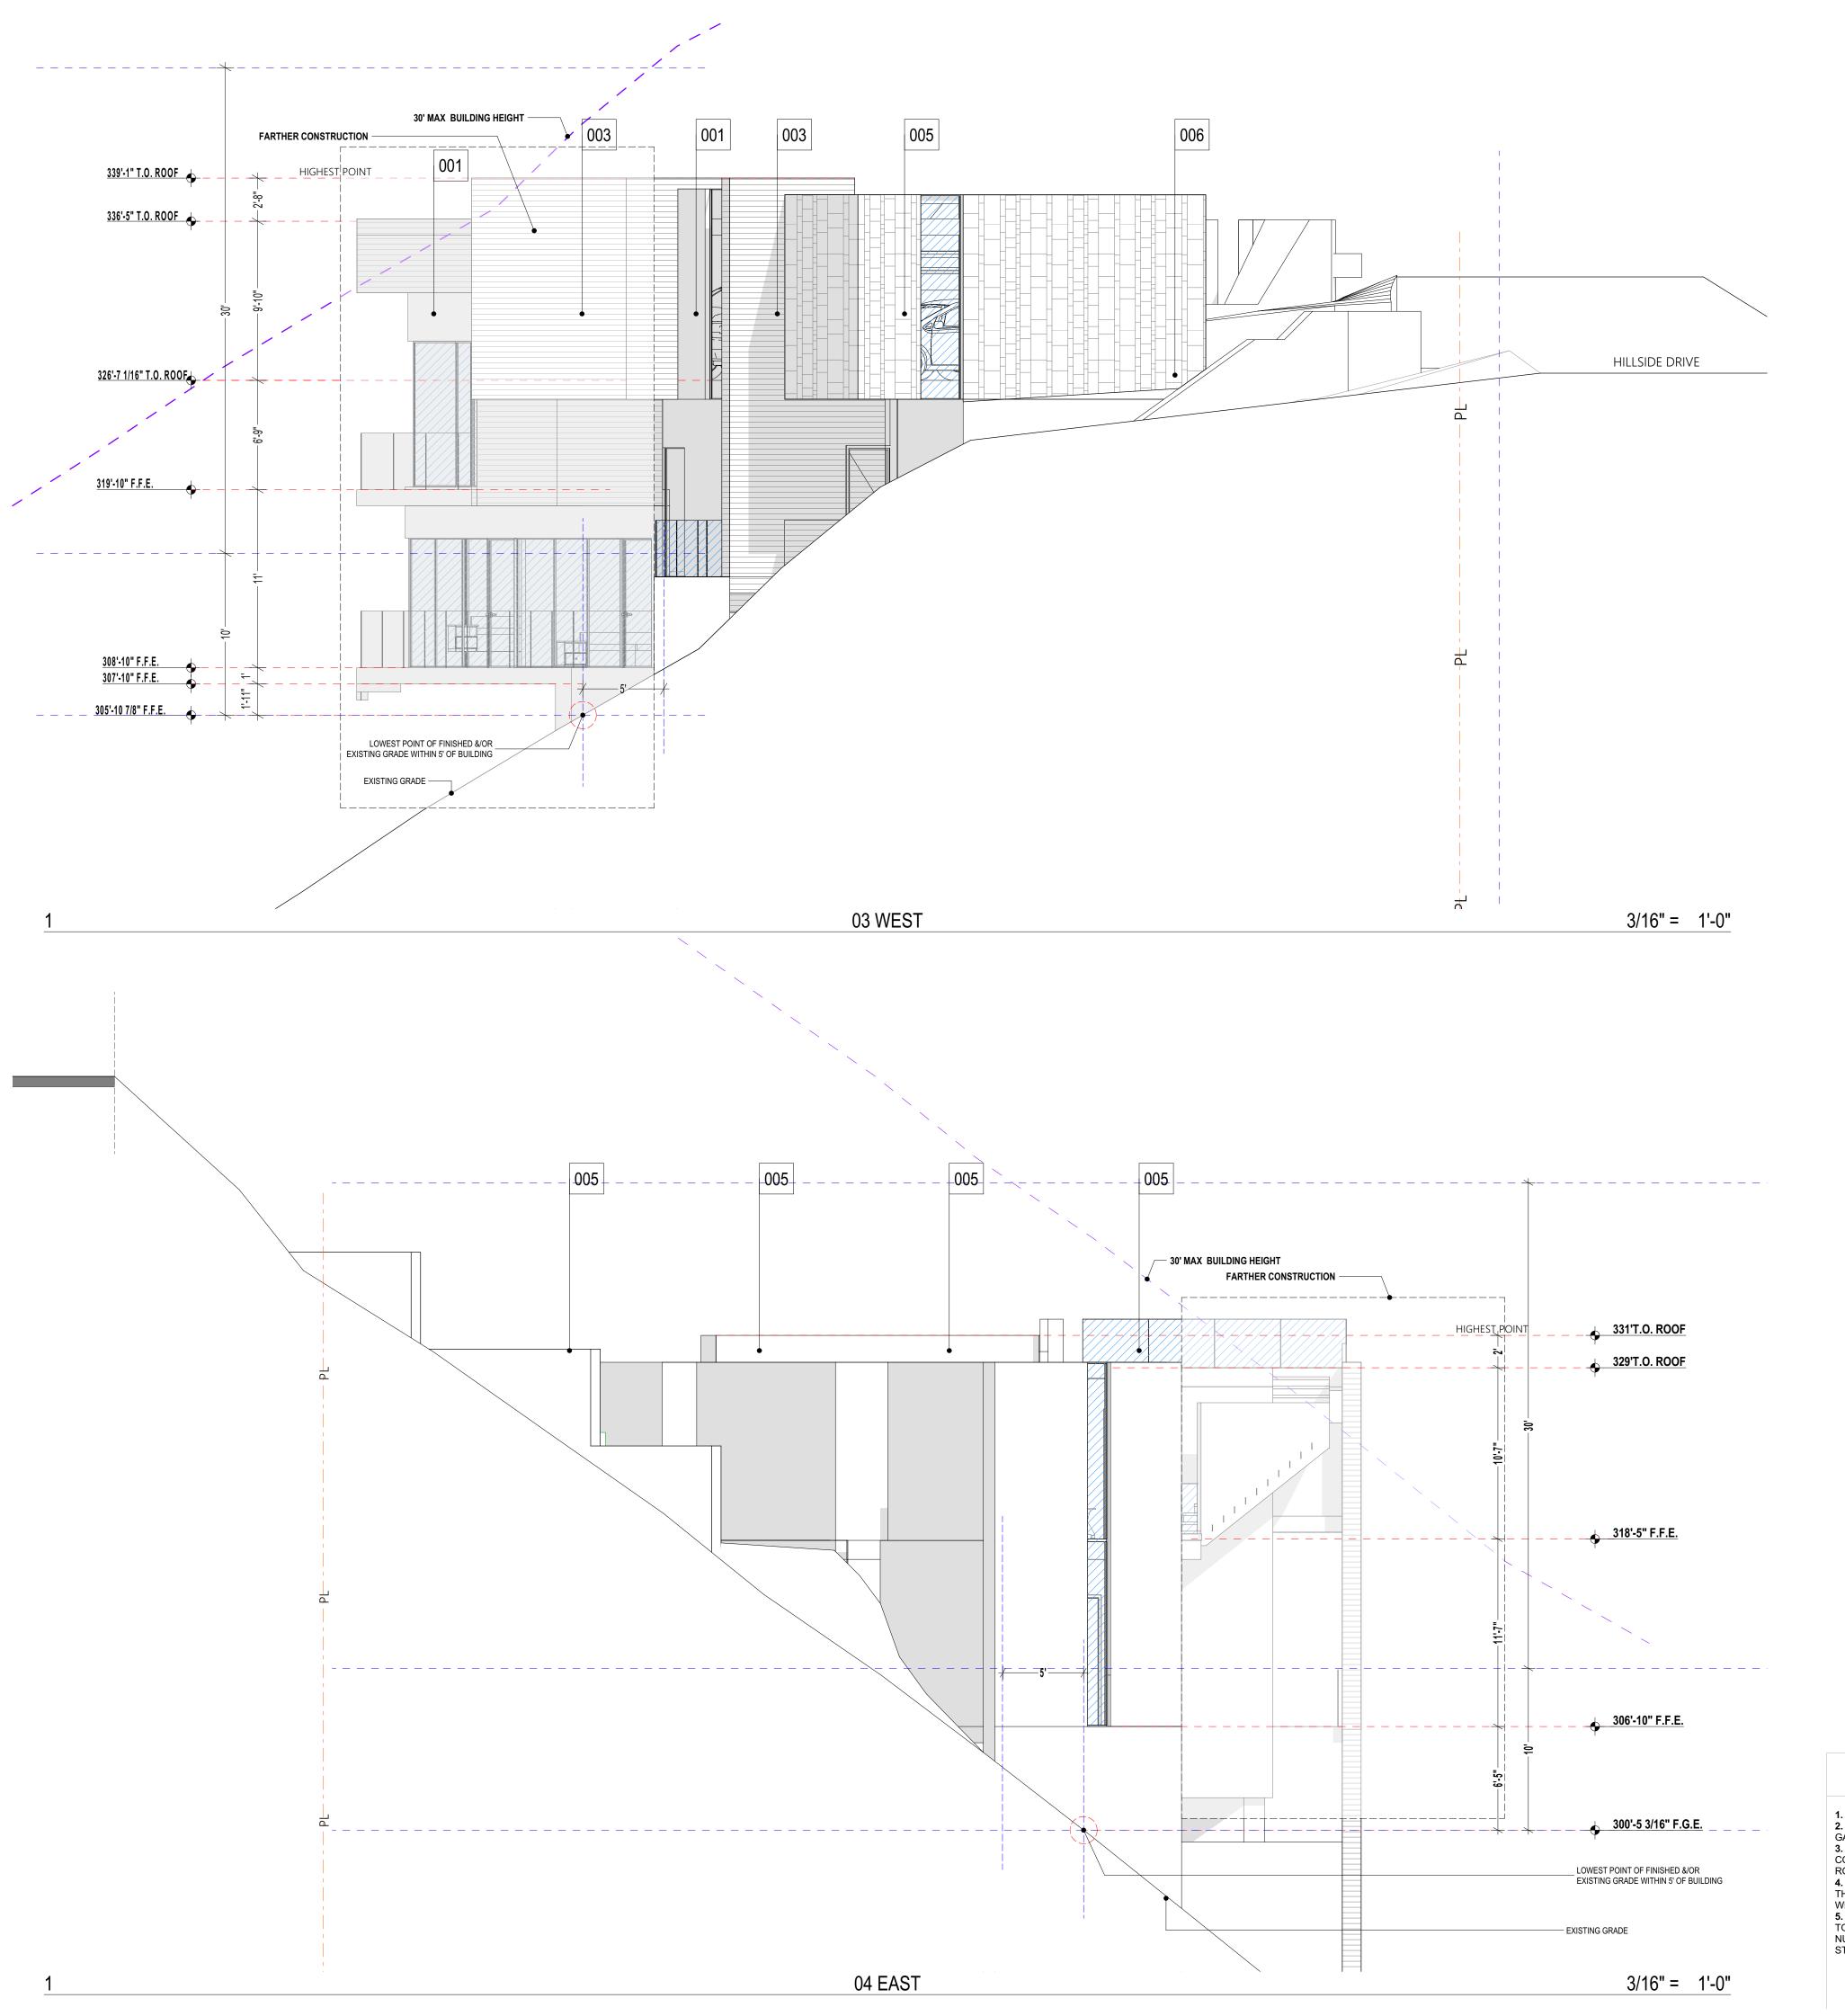
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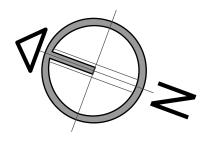


WEATHER-STRIPPED, OR OTHERWISE SEALED.

5. PREMISES IDENTIFICATION: ADDRESS NUMERALS SHALL BE PLACED IN SUCH A POSITION AS TO BE PLAINLY VISIBLE AND LEGIBLE FROM THE STREET OR ROAD FRONTING THE PROPERTY. NUMBERS SHALL CONTRAST WITH THEIR BACKGROUND. 12" HIGH NUMERALS WITH 11/2" WIDE STROKE WIDTH U.N.O.



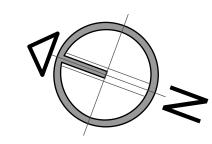



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ELEVATIONS

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CENERAL NOTES


1. REFERENCE POINTS: VERTICAL DIMENSIONS ARE TO TOP OF JOINTS AND REVEALS, U.O.N.
2. METAL FINISHES: ALL EXTERIOR STEEL AND MISCELLANEOUS METALS SHALL BE HOT DIP GALVANIZED AND PAINTED, U.O.N.
3. INSULATION: PROVIDE THE FOLLOWING R-VALUES AT EXTERIOR WALLS AND ROOF CONSTRUCTION SURROUNDING CONDITIONED SPACES IN THE BUILDING ENVELOPE U.O.N., ROOFS: R-30, WALLS: R-19, FLOOR OVERHANGS: R-19.
4. WEATHER-TIGHTNESS: ALL EXTERIOR JOINTS AND OPENINGS IN THE BUILDING ENVELOPE U.O.N., GASKETED, WEATHER-STRIPPED, OR OTHERWISE SEALED.
5. PREMISES IDENTIFICATION: ADDRESS NUMERALS SHALL BE PLACED IN SUCH A POSITION AS TO BE PLAINLY VISIBLE AND LEGIBLE FROM THE STREET OR ROAD FRONTING THE PROPERTY. NUMBERS SHALL CONTRAST WITH THEIR BACKGROUND. 12" HIGH NUMERALS WITH 11/2" WIDE STROKE WIDTH U.N.O.

KEY NOTES

WEY NOTES

NO.N.
2. METAL FORD THE ONE OF JOINTS AND REVEALS, U.O.N.
2. METAL FINISHS: LICENTAGE STUCCO - MICRO SAND FINISH, COLOR: DARK GRAY TBD 002. STANDING SEAM ROOF 003. TREATED WOOD 004. FLAT STONE CLADDING 005. EXTERIOR STUCCO - MICRO SAND FINISH, COLOR: WHITE TBD 005. EXTERIOR STUCCO - MICRO SAND FINISH, COLOR: WHITE TBD 005. EXTERIOR STUCCO - MICRO SAND FINISH, COLOR: WHITE TBD 005. EXTERIOR STUCCO - MICRO SAND FINISH, COLOR: WHITE TBD 005. EXTERIOR STUCCO - MICRO SAND FINISH, COLOR: WHITE TBD 005. GLASS RAILING 005. GLASS RAILING 005. GLASS RAILING 007. CONCRETE CLADDING TEXTURE TBD 008. GARAGE DOOR WITH TREATED WOOD COLOR TBD 009. WITHE GRANITE

# CASS RESIDENCE LANDSCAPE PLAN

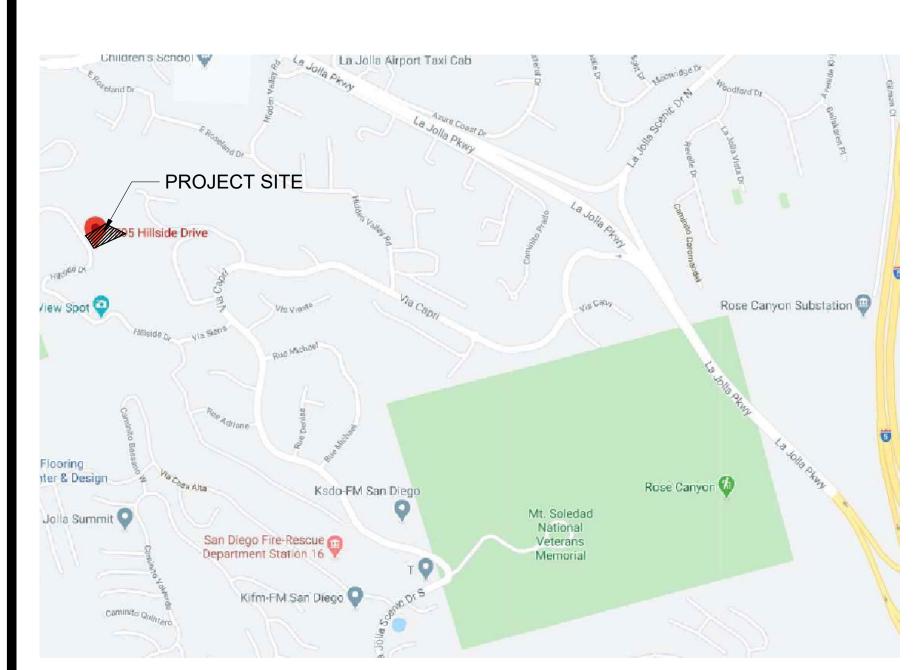





## SITE MAP



## LANDSCAPE PLANS

SHEET INDEX

#### **DESCRIPTION** SHEET NO.

.. COVER SHEET L-2. .IRRIGATION SPECS. ..PLANTING SPECS L-3.

.IRRIGATION PLAN .IRRIGATION DETAILS

..PLANTING PLAN L-7. ..PLANTING DETAILS

.BRUSH MANAGEMENT PLAN

# 04-14-20 STAMP DATE



110 COPPERWOOD WAY #P OCEANSIDE CA 92058 760-716-3100 CA. LLA#5299, C-27#944955

## DECLARATION OF RESPONSIBLE CHARGE

EXERCISED RESPONSIBLE CHARGE OVER THE DESIGN OF THIS PROJECT AS DEFINED IN SECTIONS 5615

LANDSCAPE CONCEPT PLAN. LANDSCAPE ARCHITECT'S NAME: \_\_\_SEAN R. CLARKE\_

ADDRESS: \_\_\_110 COPPERWOOD WAY #P. OCEANSIDE, CA. 92058\_ TELEPHONE NO.: \_\_\_\_760-400-1040\_

## NOTICE TO CONTRACTORS

THE EXISTENCE AND LOCATION OF ANY UNDERGROUND UTILITY PIPES OR STRUCTURES SHOWN ON THESE PLANS WERE OBTAINED BY A SEARCH OF AVAILABLE RECORDS. THESE LOCATIONS ARE APPROXIMATE AND SHALL BE CONFIRMED IN FIELD BY THE CONTRACTOR, SO THAT ANY NECESSARY ADJUSTMENT CAN BE MADE IN ALIGNMENT AND/OR GRADE OF THE PROPOSED IMPROVEMENT. THE CONTRACTOR IS REQUIRED TO TAKE DUE PRECAUTIONARY MEASURES TO PROTECT ANY UTILITY LINES SHOWN AND ANY OTHER LINES NOT OF RECORD OR NOT SHOWN ON THESE PLANS.

## SITE ADDRESS

7595 HILLSIDE DRIVE SAN DIEGO, CA

## OWNER:

CASS KOOKLANI MMK MANAGEMENT GROUP, LLC P.O. BOX 1555 LA JOLLA, CA 92038

## **ARCHITECT**

## C.D.G.I.

P.O. BOX 84180 SAN DIEGO, CA 92138 619-858-2345

## LANDSCAPE ARCHITECT

S.R. CLARKE LANDSCAPE ARCHITECT AND DEVELOPMENT 110 COPPERWOOD WAY SUITE #P OCEANSIDE, CA 92058 760-716-3100

PRIVATE CONTRACT

## PLANTING SPECIFICATIONS


CITY OF SAN DIEGO, CALIFORNIA

## CASS RESIDENCE

7595 HILLSIDE DRIVE SAN DIEGO, CA 92037-3943

PROJECT NO	DEVELOPMENT SERVICES DEPARTMENT SHEET L1 OF 8 SHEETS				
V. T.M		DATE		ENGINE	FOR CITY
	FILMED	DATE	APPROVED	BY	ESCRIPTION
NAD83 COORDINATES					
LAMBERT COORDINATES					AS-RIII TS

\_ DATE STARTED. \_ DATE COMPLETED.

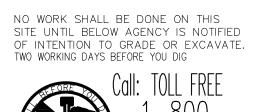

Underground Service Alert

THE LANDSCAPE/OR IMPROVEMENT PLANS ARE APPROVED FOR A PERIOD OF TWO (2) YEARS FROM THE DATE SIGNED BY THE CITY ENGINEER. AFTER THE TWO (2) YEAR PERIOD HAS LAPSED, THE ENGINEER OF RECORD MAY BE REQUIRED TO SUBMIT AND PROCESS FOR CITY ENGINEER APPROVAL, UPDATED PLANS THAT COMPLY WITH THE MOST CURRENT CITY STANDARDS, PRACTICES AND POLICIES.

PI	ANT LEGEND				
SYN	STREET TREES  M BOTANICAL NAME	COMMON NAME	SIZE	QTY	WU- COLS
М	MELALEUCA QUINQUENERVIA	CAJPUT TREE	24" BOX	2	LOW
KP	ARCHONTOPHOENIX CUNNINGH.	KING PALM	24" BOX	1	MOD.
SYN	TREES  M BOTANICAL NAME	COMMON NAME	SIZE	QTY	
K	ARCHONTOPHOENIX CUNNINGH.	KING PALM	14' B.T.H	1. 1	MOD.
Р	PHOENIX ROEBELENII	PYGMY DATE PALM	4' B.T.H.	4	MOD.
PP	PHOENIX ROEBELENII	PYGMY DATE PALM DOUBLE TRUNK	5' B.T.H.	2	MOD.
SYN	SHRUBS  M BOTANICAL NAME	COMMON NAME	SIZE	QTY	
Α	AGAVE 'SILVER LINING'	CEDROS ISLAND AGAVE	1 GAL.	16	LOW
R	KNIPHOFIA UVARIA	RED HOT POKER	1 GAL.	65	LOW
С	CALANDRINIA 'SHINNING PINK'	ROCK PURSLANE	5 GAL.	22	LOW
	## N.O. I.O. D.A.T.E.N.O.	0.41.150.05114.00.437.0511011	5.041	T	T

#### GROUNDCOVER

J | JUNCUS PATENS

LB | RHUS INTEGRIFOLIA

GRU	JUNDCUVER						
SYM	<b>BOTANICAL NAME</b>	COMMON NAME SI	ZE S	SQFT	-		
	4-8" BAJA CRESTA RUBBLE ( BY SOUTHWEST BOULDER).						
	CAREX DIVULSA	EUROPEAN GREY SEDGE	1 GAL. 12" O.C.	50	MOD.		
	MAHONIA AQUIFOLIUM 'COMPACTA	COMPACT OREGON GRAPE	1 GAL. 30" O.C.	50	LOW		

CALIFORNIA GRAY RUSH

LEMONADE BERRY

5 GAL. | 16 | MOD.

5 GAL. | 16 | LOW

## MISC. SYM DESCRIPTION

BRUSH MANAGEMENT ZONE 1

BRUSH MANAGEMENT ZONE 2

#### **LANDSCAPE NOTES:**

- ALL LANDSCAPE AND IRRIGATION SHALL BE IN CONFORMANCE WITH THE CITY OF SAN DIEGO LANDSCAPE STANDARDS MANUAL ORDINANCE AND REQUIREMENTS OF THE JOLLA SHORES PLANNED DISTRICT ORDINACE.
- 2. THIS PROJECTS ZONE 1 SHALL BE IRRIGATED BY A PERMANENT AUTOMATED SYSTEM WITH ALL VALVES AND PIPING INSTALLED BELOW GRADE. ZONE 2 TO USE ABOVE GROUND TEMPORARY IRRIGATION IN DISTURBED AND RE-VEGATADED AREAS.
- 3. THE SYSTEM WILL BE PROGRAMMED AND OPERATED TO MAXIMIZE THE EFFICIENCY OF THE SYSTEM AND LIMIT THE WATER CONSUMPTION. THE SYSTEM WILL BE DESIGNED TO ACHIEVE 100% COVERAGE.
- 4. ALL PLANTING AREAS ARE TO RECEIVE A 3" LAYER OF ECO-MULCH.
- 5. THE PROPERTY OWNER WILL BE RESPONSIBLE FOR THE MAINTENANCE OF THE PROJECT LANDSCAPE AND IRRIGATION SYSTEMS.
- 6. THIS PROJECT IS LOCATED IN A VERY HIGH FIRE HAZARD ZONE THIS PROJECT PROPOSES TO PROVIDE A 35' WIDE ZONE 1, AND FROM ZONE 1 TO PROPERTY LINE OR 65' ZONE 2.

ZONE-1: EXISTING LANDSCAPE SHALL HAVE AN AVERAGE MAXIMUM MATURE HEIGHT OF 24" OR LESS, OR WILL BE MAINTAINED AT 24" OR LESS.

ZONE-2: INDIVIDUAL NON-IRRIGATED PLANT GROUPINGS OVER 18" IN HEIGHT MAY BE RETAINED, PROVIDED THEY DO NOT EXCEED 400 SQUARE FEET IN AREA AND THEIR COMBINED COVERAGE DOES NOT EXCEED 30% OF THE TOTAL ZONE-2 AREA. SHRUBS IN NEW PLANTING AREAS (IF NEEDED) SHALL HAVE AVERAGE MAXIMUM MATURE HEIGHT OF 24" OR LESS OR WILL BE MAINTAINED @ 24" OR LESS..

- 7. REPLANTING OF EXISTING SLOPES: RE-VEGETATE ANY DISTURBED SLOPE ACCORDING TO LANDSCAPE PLAN SHEET L1.
- 8. ALL LANDSCAPE PROVIDED TO MEET THE 30% AREA REQUIREMENTS SHALL BE INSTALLED AS REQUIRED BY THE LA JOLLA SHORES PLANNED DISTRICT ORDINANCE; ALL REQUIRED LANDSCAPE INSPECTIONS MUST BE OBTAINED PRIOR TO ISSUANCE OF THE FINAL INSPECTION.
- 9. REFER TO THE CITY OF SAN DIEGO LDC, SECTION 142.0412 (g) & (h) FOR ADDITIONAL BRUSH MANAGEMENT REQUIREMENTS.
- 10. NON-NATIVE PLANTS READILY CAPABLE OF REPRODUCING AND SPREADING INTO NATIVE, NO-IRRIGATED AREAS ARE PROHIBITED IN ALL TRANSITIONAL LANDSCAPES.
- 11. GRADES / DISTURBED PAD AND SLOPE AREAS SHALL BE HYDROSEEDED TO PREVENT EROSION, IN THE EVENT THAT CONSTRUCTION OF THE BUILDING DOES NOT OCCUR WITH 30 DAYS OF GRADING. HYDROSEED SHALL BE IRRIGATED OR REAPPLIED AS NECESSARY TO ESTABLISH GROWTH.
- 12. MINIMUM TREE SEPARATION DISTANCE:


TRAFFIC SIGNALS / STOP SIGNS - 20 FEET
UNDERGROUND UTILITY - 5 FEET (10' FOR SEWER)

ABOVE GROUND UTILITY STRUCTURES - 10 FEET

DRIVEWAY (ENTRIES) 10 FEET

INTERSECTION (INTERSECTING CURB LINES OF TO STREET) -25 FEET

- 13. ALL GRADED, DISTURBED OR ERODED AREAS THAT WILL NOT BE PERMANENTLY PAVED OR COVERED BY STRUCTURES SHALL BE PERMANENTLY REVEGETATED AND IRRIGATED IN ZONE 1, ZONE 2 TO BE PERMANENTLY REVEGETATED AND A TEMPORARY IRRIGATION SYSTEM SHALL BE INSATLLED, AS SHOWN IN TABLE 142-04F AND IN ACCORDANCE WITH THE STANDARD IN THE SAN DEIGO MUNICIPAL CODE, SECTION 142.0411. ALL REQUIRED REVEGETATION AND EROSION CONTROL SHALL BE COMPLETED WITHIN 90 CALENDAR DAYS OF THE COMPLETION OF GRADING OR DISTURBANCES.
- 14. A MINIMUM ROOT ZONE OF 40SF IN AREA SHALL BE PROVIDED FOR ALL TREES. THE MINIMUM DIMENSION FOR THIS AREAS SHALL BE 5 FEET, PER SDMC 142.0403(b)(5).
- 15. MAINTENANCE: AL REQUIRED LANDSCAPE AREAS SHALL BE MAINTAINED BY OWNER. LANDSCAPE AND IRRIGATION AREAS IN THE PUBLIC RIGHT-OFF-WAY SHALL BE MAINTAINED BY OWNER. THE LANDSCAPE AREAS SHALL BE MAINTAINED FREE OF DEBRIS AND LITTER, AND ALL PLANT MATERIAL SHALL BE MAINTAINED IN A HEALTHY GROWING CONDITION. DISEASED OR DEAD PLANT MATERIAL SHALL BE SATISFACTORY TREATED OR REPLACED PER THE CONDITIONS OF THE PERMIT.
- 16. TREES SHALL BE MAINTAINED SO THAT ALL BRANCHES OVER PEDESTRIAN WALKWAYS ARE 6 FEET ABOVE THE WALKWAY GRADE AND BRANCHES OVER VEHICULAR TRAVEL ARE 16 FEET ABOVE THE GRADE OF THE TRAVEL WAY PER THE SAN DIEGO MUNICIPAL CODE, SECTION 142.0403(b)(10).
- 17. IF ANY REQUIRED LANDSCAPE INDICATED ON THE APPROVED CONSTRUCTION DOCUMENT PLANS IS DAMAGED OR REMOVED DURING DEMOLITION OR CONSTRUCTION, IT SHALL BE REPAIRED AND/OR REPLACED IN KIND AND EQUIVALENT SIZE PER THE APPROVED DOCUMENTS TO THE SATISFACTION OF THE DEVELOPMENT SERVICE DEPARTMENT WITHIN 30 DAYS OF DAMAGE.

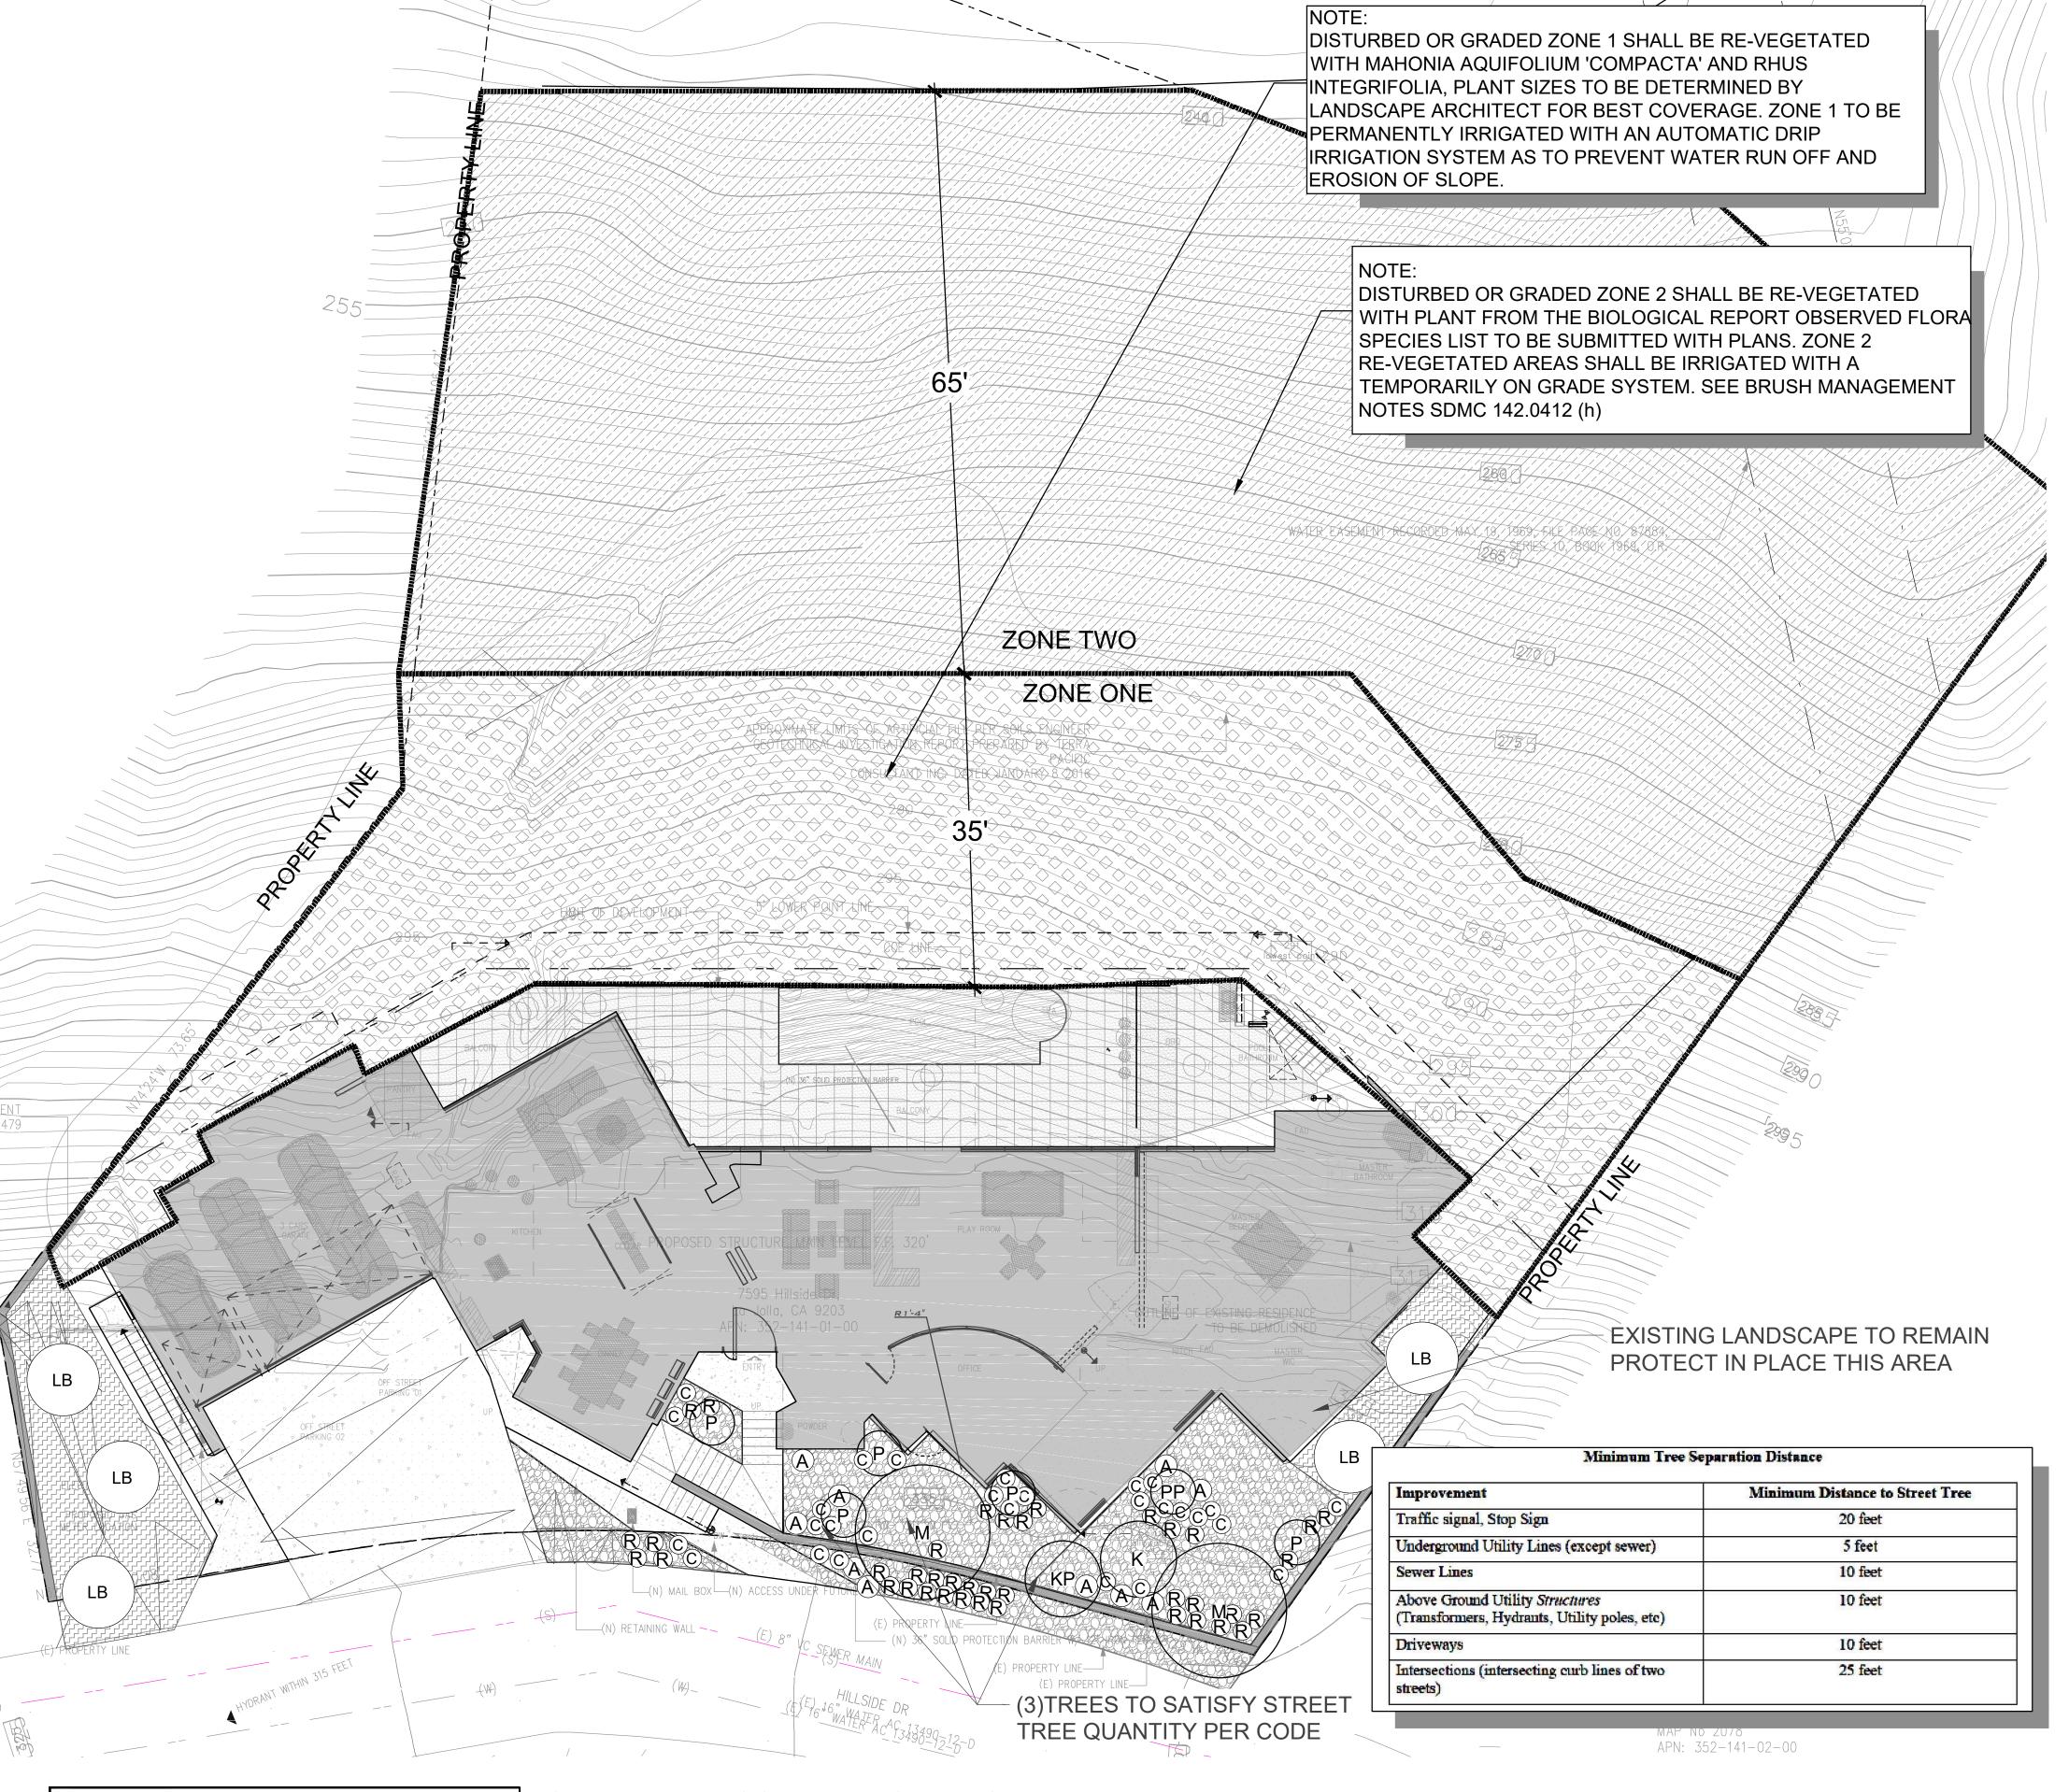

SHEET NO. DESCRIPTION

L-1.....BRUSH MANAGEMENT PLAN
L-3 LANDSCAPE AREA DIAGRAM

## SITE ADDRESS

7595 HILLSIDE DRIVE SAN DIEGO, CA

## OWNER:

CASS KOOKLANI MMK MANAGEMENT GROUP, LLC P.O. BOX 1555 LA JOLLA, CA 92038

## ARCHITECT

C.D.G.I. P.O. BOX 84180 SAN DIEGO, CA 92138 619-858-2345

## LANDSCAPE ARCHITECT


S.R. CLARKE LANDSCAPE ARCHITECT AND DEVELOPMENT 110 COPPERWOOD WAY SUITE #P OCEANSIDE, CA 92058 760-716-3100









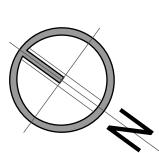

2nd review - 5.19.2020 3rd review - 5.28.2020 4th review - 10.14.2020

DATE.
12.15.2020
CITY SUBMITTAL.


SAN DIEGO
SCALE.
INDICATE IN DRAW
DRAW.
E.M.

SHEET TITLE:

JOB NO.

LANDSCAPE PLAN

L1 - 3

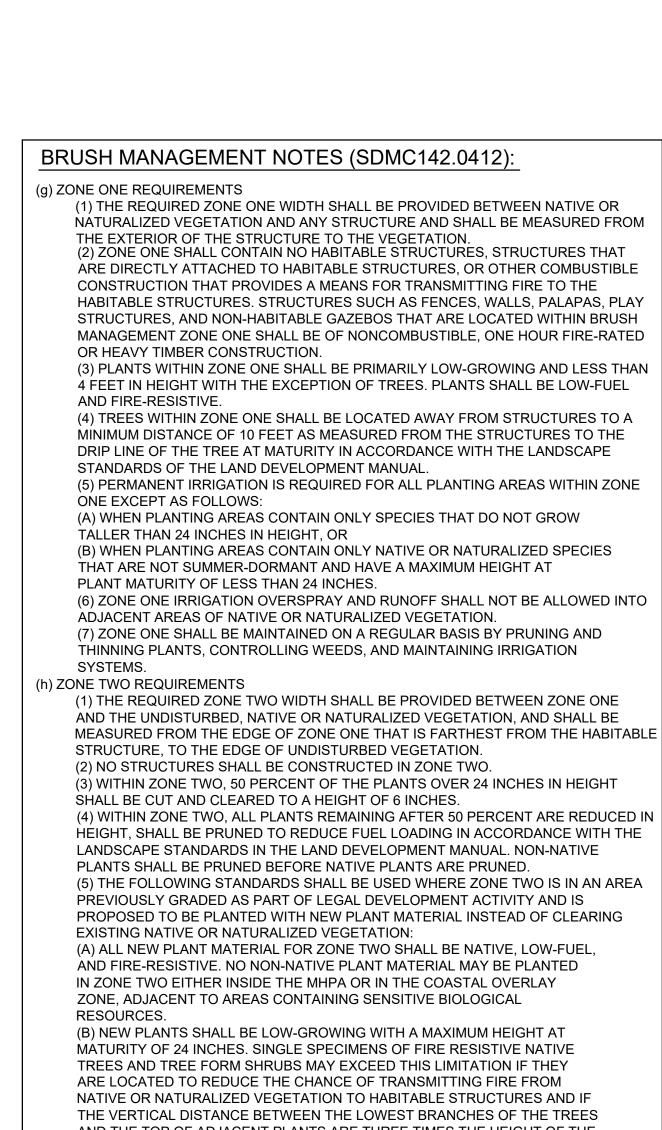



AND THE TOP OF ADJACENT PLANTS ARE THREE TIMES THE HEIGHT OF THE ADJACENT PLANTS TO REDUCE THE SPREAD OF FIRE THROUGH LADDER FUELING.

(C) ALL NEW ZONE TWO PLANTING SHALL BE IRRIGATED TEMPORARILY UNTIL ESTABLISHED TO THE SATISFACTION OF THE CITY MANAGER. ONLY LOW-FLOW, LOW-GALLONAGE SPRAY HEADS MAY BE USED IN ZONE TWO. OVER SPRAY AND RUNOFF FORM THE IRRIGATION SHALL NOT DRIFT OR FLOW INTO ADJACENT AREAS OF NATIVE OR NATURALIZED VEGETATION. TEMPORARY IRRIGATION SYSTEM SHALL BE REMOVED UPON APPROVED ESTABLISHED OF THE PLANTINGS.PERMANENT IRRIGATION IS NOT ALLOWED IN ZONE TWO.

(D) WHERE ZONE TWO IS BEING REVEGETATED AS A REQUIREMENT OF SECTION 142.0411(A), REVEGETATION SHALL COMPLY WITH THE SPACING STANDARDS IN THE LAND DEVELOPMENT MANUAL. FIFTY PERCENT OF THE PLANTING AREA SHALL BE PLANTED WITH MATERIAL THAT DOES NOT GROW TALLER THAN 24 INCHES. THE REMAINING PLANTING AREA MAY BE PLANTED WITH TALLER MATERIAL, BUT THIS MATERIAL SHALL BE MAINTAINED IN ACCORDANCE WITH THE REQUIREMENTS FOR EXISTING PLANT MATERIAL IN ZONE TWO.


(6) ZONE TWO SHALL BE MAINTAINED ON A REGULAR BASIS BY PRUNING AND THINNING PLANTS, REMOVING INVASIVE SPECIES, AND CONTROLLING WEEDS. (7) EXCEPT AS PROVIDED IN SECTION 142.0412(I), WHERE THE REQUIRED ZONE ONE WIDTH SHOWN IN TABLE 142-04H CANNOT BE PROVIDED ON PREMISES WITH EXISTING STRUCTURES, THE REQUIRED ZONE TWO WIDTH SHALL BE INCREASED BY ONE FOOT FOR EACH FOOT OF REQUIRED ZONE ONE WIDTH THAT CANNOT BE PROVIDED.

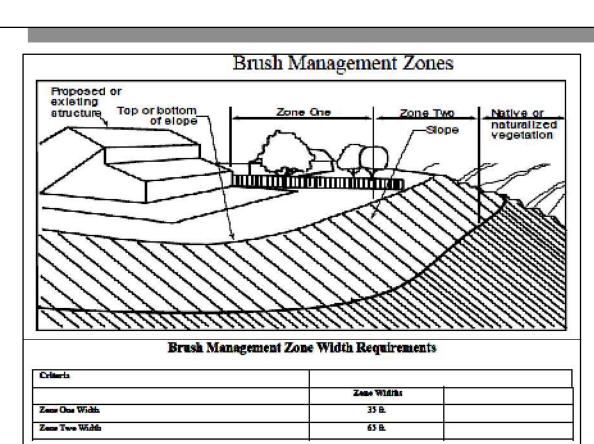

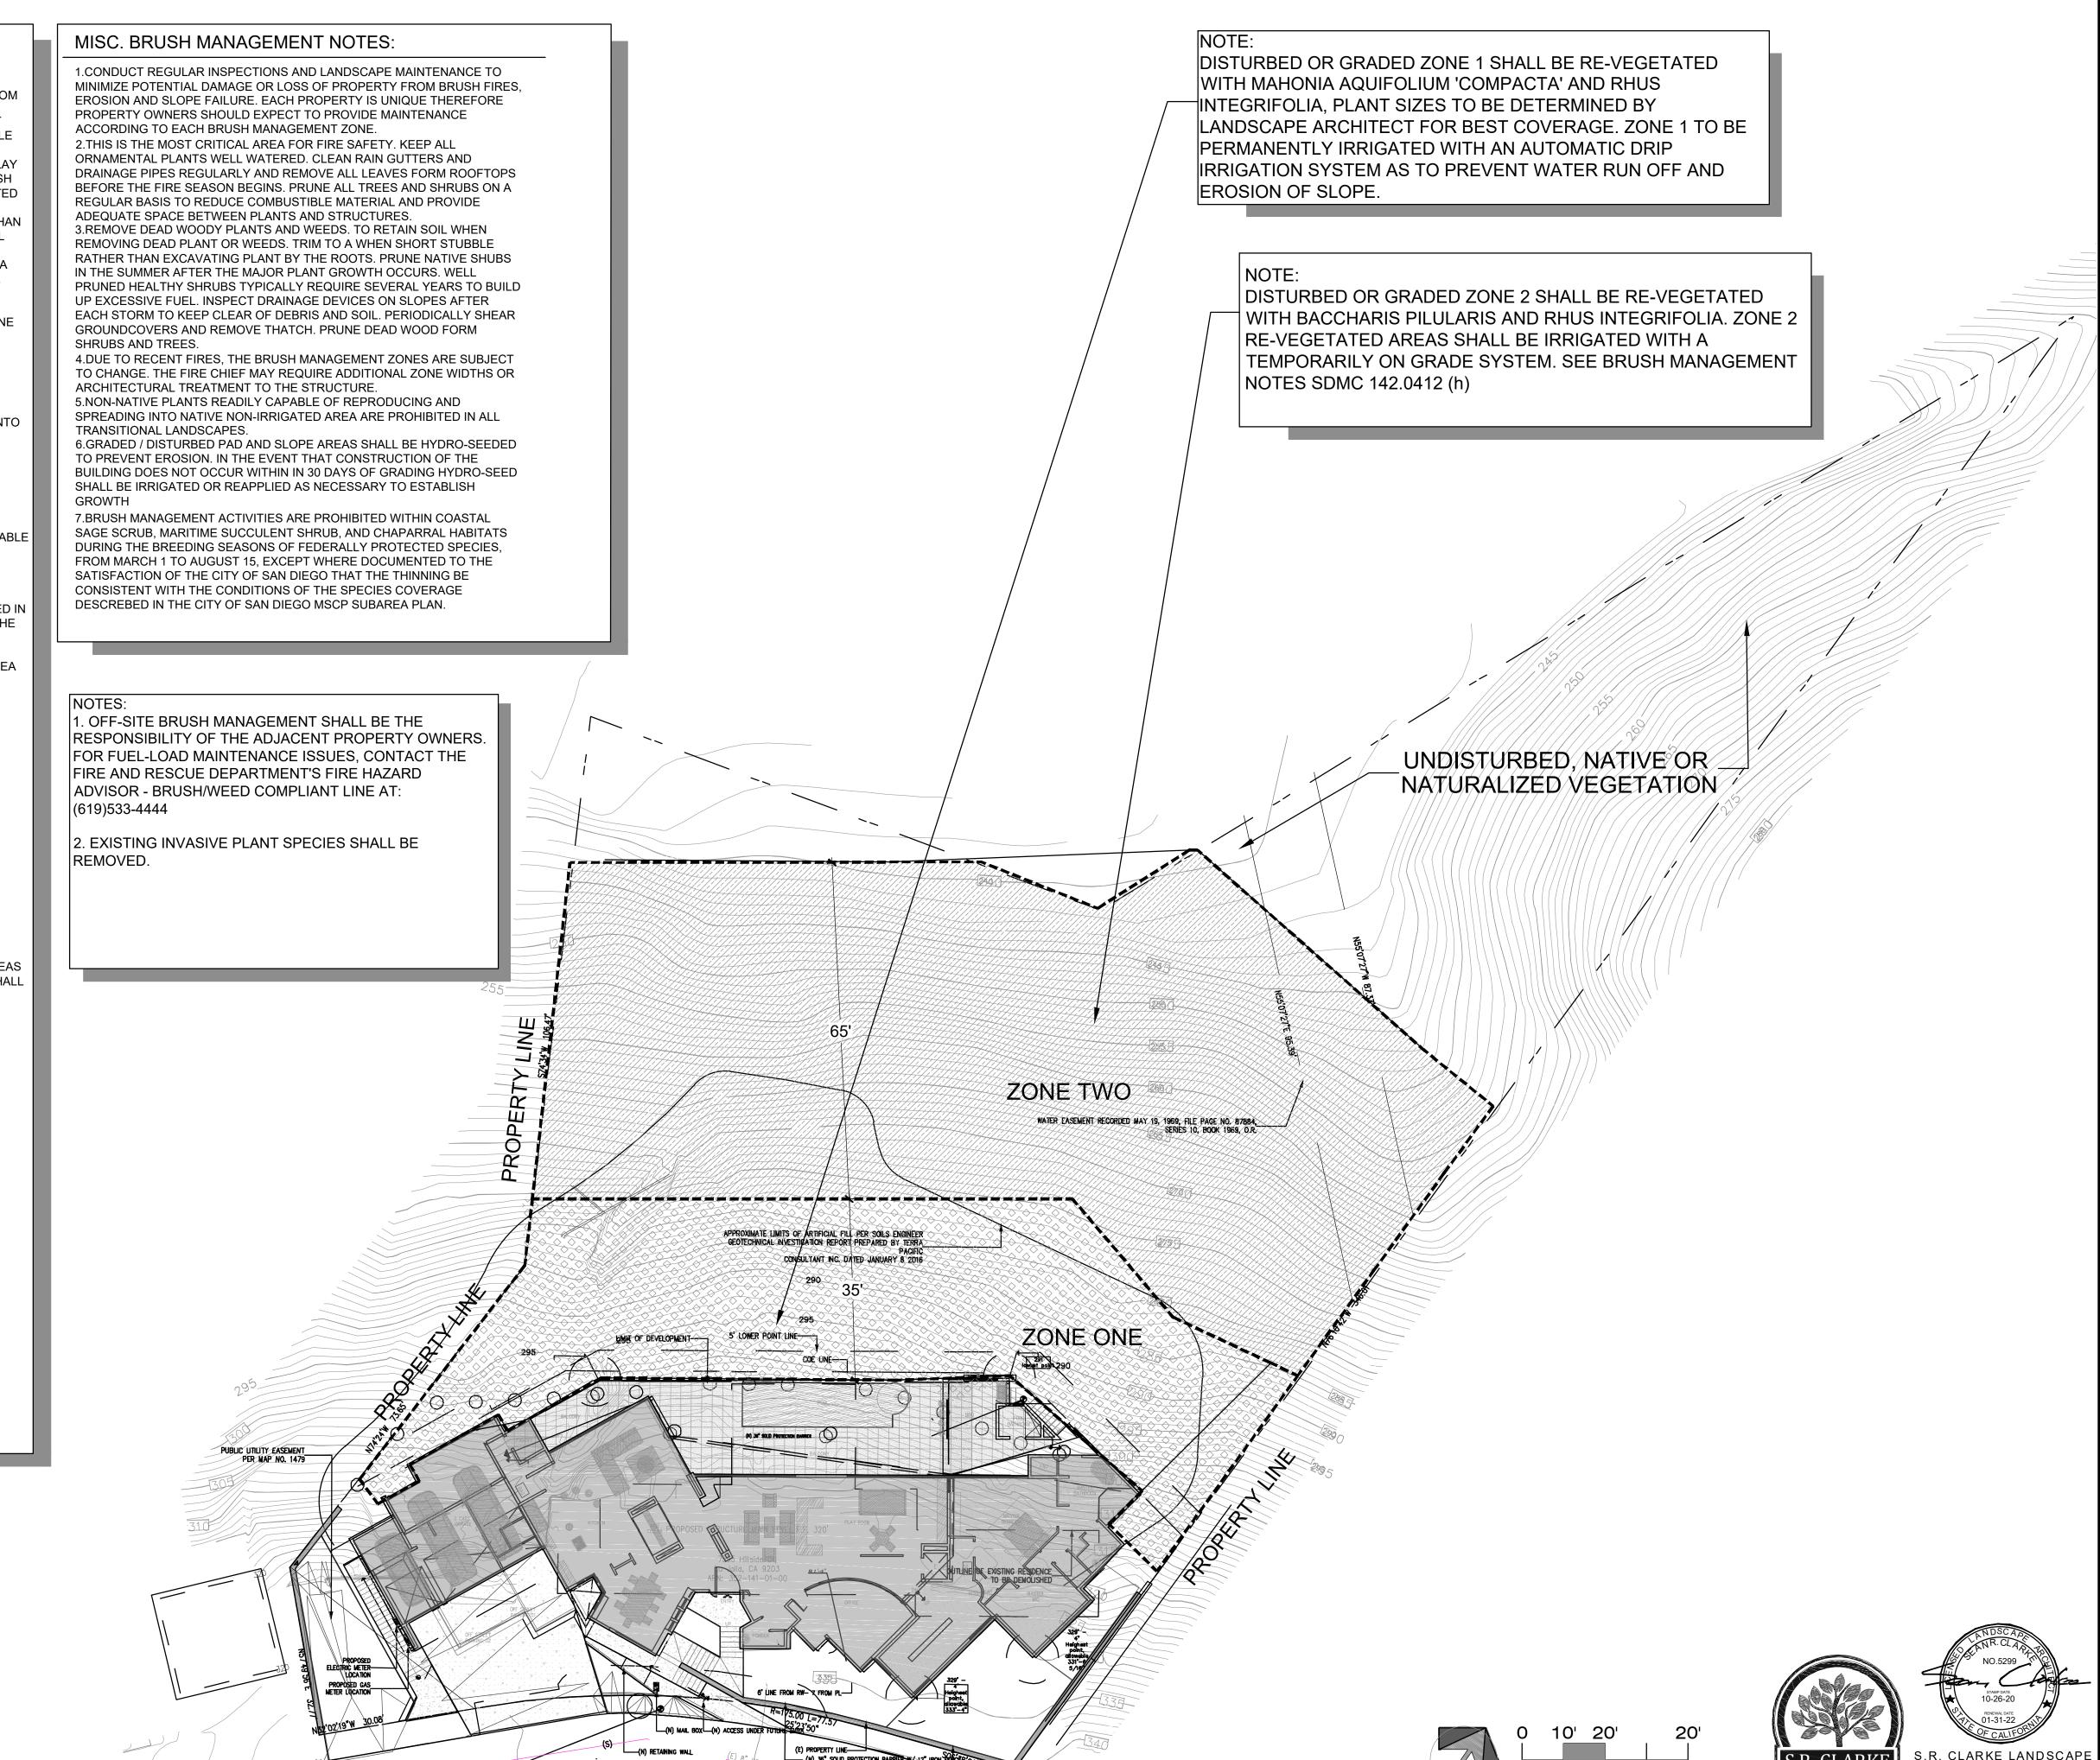

LOT B



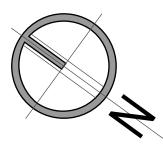

2nd review - 5.19.2020 3rd review - 5.28.2020 4th review - 10.14.2020

.1

PROJECT NAME:

DATE.
12.15.2020
CITY SUBMITTAL.
SAN DIEGO
SCALE.

DRAW.
E.M.
JOB NO.

SHEET TITLE:

BRUSH MANAGEMENT PLAN

ARCHITECTURE & DEVELOPMENT 110 COPPERWOOD WAY # P


OCEANSIDE CA 92058

P.# 760-716-3100

L2 - 3





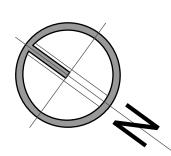

DATE. 12.15.2020 CITY SUBMITTAL. SAN DIEGO SCALE. INDICATE IN DRAW DRAW.


> JOB NO. SHEET TITLE:

E.M.

LANDSCAPE AREA DIAGRAM





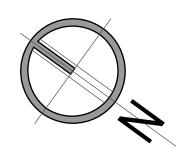

NORTH 2nd review - 5.19.2020 3rd review - 5.28.2020

4th review - 10.14.2020

DATE. 12.15.2020 CITY SUBMITTAL. SAN DIEGO SCALE. INDICATE IN DRAW DRAW.

JOB NO. SHEET TITLE:

FIRE PLAN

E.M.

F.O 1